



## Bid Notice Abstract

### Request for Quotation (RFQ)

**Reference Number** 11921682  
**Procuring Entity** CARLOS HILADO MEMORIAL STATE UNIVERSITY  
**Title** Procurement of Labor and Materials for the Repair and Conversion of Male and Female Toilets to All Gender Comfort Rooms at Alijis Campus  
**Area of Delivery** Negros Occidental

<b>Solicitation Number:</b>	RFQ 25-107	<b>Status</b>	<b>Pending</b>
<b>Trade Agreement:</b>	Implementing Rules and Regulations	<b>Associated Components</b>	1
<b>Procurement Mode:</b>	Negotiated Procurement - Small Value Procurement (Sec. 53.9)	<b>Bid Supplements</b>	0
<b>Classification:</b>	Civil Works	<b>Document Request List</b>	0
<b>Category:</b>	Construction Projects	<b>Date Published</b>	27/03/2025
<b>Approved Budget for the Contract:</b>	PHP 700,000.00	<b>Last Updated / Time</b>	26/03/2025 10:55 AM
<b>Delivery Period:</b>	60 Day/s	<b>Closing Date / Time</b>	03/04/2025 09:00 AM
<b>Client Agency:</b>			
<b>Contact Person:</b>	Rowena De la Vida Prado Administrative Assistant II Mabini Street Talisay City Negros Occidental Philippines 6115 63-34-7120005 Ext.142 63-939-9296624 bac.sec@chmsu.edu.ph		

#### Description

Republic of the Philippines  
 CARLOS HILADO MEMORIAL STATE UNIVERSITY  
 Talisay City, Negros Occidental  
 Mobile Phone Number: 0939 929 6624  
 bac.sec@chmsu.edu.ph

REQUEST FOR QUOTATION  
 Page 1 of 14  
 Date: MARCH 25, 2025  
 Quotation No. 25-107

Please quote your lowest price on the item/s listed below, stating the shortest time of delivery and submit your quotation duly signed by your representative not later than \_\_\_\_\_ in the return envelope attached herewith.

DR. ANDREW EUSEBIO S.TAN  
 BAC Chairman

#### NOTE:

1. ALL ENTRIES MUST BE TYPEWRITTEN
2. DELIVERY PERIOD WITHIN 60 CALENDAR DAYS
3. WARRANTY SHALL BE FOR A PERIOD OF SIX (6) MONTHS FOR SUPPLIES & MATERIALS, ONE (1) YEAR FOR EQUIPMENT, FROM DATE OF ACCEPTANCE BY THE PROCURING ENTITY

4. PRICE VALIDITY SHALL BE FOR A PERIOD OF \_\_\_\_\_ CALENDAR DAYS
5. G-EPIS REGISTRATION CERTIFICATE SHALL BE ATTACHED UPON SUBMISSION OF THE QUOTATION
6. BIDDERS SHALL SUBMIT ORIGINAL BROCHURES SHOWING CERTIFICATIONS OF THE PRODUCT BEING OFFERED

#### ITEM DESCRIPTION OF WORKS QTY. UNIT MATERIAL COST LABOR COST TOTAL COST

NO. Unit Cost Material Sub-Total Cost Unit Cost Labor Sub-Total Cost

ONE (1) LOT

LABOR AND MATERIALS FOR THE REPAIR AND CONVERSION OF MALE AND FEMALE TOILETS TO ALL-GENDER COMFORT ROOMS AT ALIJIS CAMPUS

#### SCOPE OF WORKS

##### 1.0 GENERAL WORKS

- 1.1 Chipping of Slab and Wall Tiles (Affected Portion)
- 1.2 Hauling of Waste Materials
- 1.3 Clearing, Hauling, and Cleaning of site

##### 2.0 CARPENTRY WORKS

- 2.1 Phenolic Shelves, Urinal and Toilet Partitions
- 2.2 Signage

##### 3.0 ROOFING WORKS

- 3.1 End Flashing

##### 4.0 MASONRY WORKS

- 4.1 Construction of Footwash, Expansion on Bath Canal and Tubular Steel Base Cement Cover
- 4.2 Concrete Door Jamb

##### 5.0 TILE WORKS

- 5.1 Installation of Wall Tiles
- 5.2 Installation of Floor Tiles
- 5.3 Installation of Countertop Lavatory Tiles

##### 6.0 PLUMBING WORKS

- 6.1 Installation of Soil Pipe
- 6.2 Installation of Waste Pipe
- 6.3 Installation of Water Supply Line
- 6.4 Installation of Plumbing Fixtures
- 6.5 Rehabilitation of Septic Tank

##### 7.0 ELECTRICAL WORKS

- 7.1 Lighting and Outlet Fixtures
- 7.2 Wires and Cables
- 7.3 Conduits

##### 8.0 PAINTING WORKS

- 8.1 Surface Preparation and Repainting of Exterior Walls
- 8.2 Surface Preparation and Repainting of Interior and Exterior Ceiling
- 8.3 Surface Preparation and Repainting of Interior Walls in Faux Concrete Wall Finished
- 8.4 Repainting of Existing Door

##### 9.0 STEEL WORKS

- 9.1 Mesh Wire Cover at the Shower Area

##### 10.0 SUPPLY AND INSTALLATION OF GLASS MIRROR AND STEEL DOOR

- 10.1 Supply and Installation of Glass Mirrors
- 10.2 Supply and Installation of Steel Doors

##### 11.0 MISCELLANEOUS

11.1 FOR ALL OTHER ITEMS that are not included on listed Bill of Quantities in your Bid but are deemed necessary for the completion of the works and the delivery of the project and in full compliance with all the requirements of the occupancy permit.

Note: All Design & Plans Should be referred to the Identified parameters.

#### BILL OF QUANTITIES

##### 1.0 GENERAL WORKS

- 1.1 Chipping of Slab and Wall Tiles (Affected Portion) 1 lot
- 1.2 Hauling of waste materials 1 lot
- 1.3 Clearing, Hauling, and Cleaning of site 1 lot

Sub-total, 1.0 (General Works)

##### 2.0 CARPENTRY WORKS

- 2.1 Phenolic Shelves, Urinal and Toilet Partitions
  - 2.1.1 Solid and Compacted Phenolic Board Shelf (4' x 8' x 3/4" thick) 8 set
  - 2.1.2 Edging Strip 3/4" (Walnut) 20 m
  - 2.1.3 Black Aluminum U-Channel 3/4" (2m) 6 lght
- 2.2 Signage
  - 2.2.1 Laminated Wood Signage w/ Metal Frame Set 2 set

Sub-total, 2.0 (Carpentry Works)

##### 3.0 ROOFING WORKS

- 3.1 End Flashing

- 3.1.1 Pre-painted Flashing GA 24 (0.7mm x 2.44m) 15 In.m.
- 3.1.2 Angle Bar ( 1" x 1 1/2" x 1/8" x 6m) 5 lght
- 3.1.3 10mm Ø DSB 5 lght

Sub-total, 3.0 (Roofing Works)

#### 4.0 MASONRY WORKS

- 4.1 Construction of Footwash, Expansion of Bath Canal and Tubular Steel Base Cement Cover
- 4.1.1 Portland Cement 5 bag
- 4.1.2 Sand 1 cu.m.
- 4.1.3 Gravel (3\4) 1 cu.m.
- 4.1.4 10mm Ø DSB 4 lght
- 4.1.5 Tie Wires 1 K
- 4.2 Concrete Door Jamb
- 4.2.1 Portland Cement (40kg) 5 bag
- 4.2.2 Concrete Accelerating Admixture 5 bag
- 4.2.3 Mixing Sand 1 cu.m
- 4.2.4 8 mm ø x 6 m DSB 12 lght
- 4.2.5 10 mm ø x 6 m DSB 8 lght
- 4.2.6 #16 G.I. Tie Wires 6 kg

Sub-total, 4.0 (Masonry Works)

#### 5.0 TILE WORKS

- 5.1 Installation of Wall Tiles
- 5.1.1 16"x16" Wood Cream, Floor Tiles 320 pcs
- 5.1.2 12"x12" Vienne Charcoal, Wall Tiles 20 pcs
- 5.1.3 Portland Cement 11 bag
- 5.1.4 ABC Tile Adhesive 15 bag
- 5.1.5 Tile Grout 8 kg

#### 5.2 Installation of Floor Tiles

- 5.2.1 16"x16" Yale Dark, Floor Tiles 100 pcs
- 5.2.2 Portland Cement 4 bag
- 5.2.3 ABC Tile Adhesive 4 bag
- 5.2.4 Tile Grout 5 kg

#### 5.2 Installation of Countertop Lavatory Tiles

- 5.2.1 16"x16" Black Pearl Granite Tiles 15 pcs

Sub-total, 5.0 (Tile Works)

#### 6.0 PLUMBING WORKS

##### 6.1 Installation of Soil Pipe

- 6.1.1 PVC Sanitary Pipe (Orange Pipe) 6"Ø x 10'ft. 5 lght
- 6.1.2 Water closet PVC Bend Fittings 6" x 6" 2 pcs
- 6.1.3 PVC Wye 6" x 6" 2 pcs
- 6.1.5 Pvc Sanitary fittings Elbow 90 degrees 1/4 bend 6"Ø 4 pcs
- 6.1.6 PVC Sanitary Clean out 6" 5 pcs
- 6.1.7 PVC Coupling Sanitary Fitting 6" 4 pcs
- 6.1.8 PVC Reducer Sanitary Fitting 4"-6" 4 pcs
- 6.1.9 P-trap set 1-1/2 8 pcs

##### 6.2 Installation of Waste Pipe

- 6.2.1 PVC Sanitary Pipe (Orange Pipe) 2"Ø 7 lght
- 6.2.2 PVC Sanitary Pipe (Orange Pipe) 4"Ø 10 lght
- 6.2.3 Wye Reducer 4" x 2" 22 pcs
- 6.2.4 PVC Coupling Sanitary Fitting 2" 4 pcs
- 6.2.5 PVC Sanitary Clean out 2" 2 pcs
- 6.2.6 Sanitary P-Trap 2" 1 pcs
- 6.2.7 Floor Drain 4"x4" 2 pcs

##### 6.3 Installation of Water Supply Line

- 6.3.1 PE Pipe to PVC connector 3/4" ø 2 pcs
- 6.3.2 PVC Pipe 3/4" ø (Blue Pipe) 8 lght
- 6.3.3 PVC Pipe 1/2" ø (Blue Pipe) 4 lght
- 6.3.4 PVC Fittings Elbow 45 Degrees 1/2" 4 pcs
- 6.3.5 PVC Reducer 3/4" to 1/2"ø 2 pcs
- 6.3.6 PVC Coupling Tee 3/4" 4 pcs
- 6.3.7 PVC Fittings Tee 1/2" 4 pcs
- 6.3.8 PVC Gate Valve 1/2" 1 pcs
- 6.3.9 PVC Gate Valve 3/4" 1 pcs

##### 6.4 Installation of Plumbing Fixtures

- 6.4.1 Two Piece Water Closet 11 pcs
- 6.4.3 Square Vessel Basin (370 x 480 x 130mm) 2 pcs
- 6.4.4 U Shaped Handicap Grab Bar (600mm-750mm) 2 pcs
- 6.4.5 2 Walls Stainless Steel Angled Grab Bar w/ Snap Flange Bobrick (750 x 1000mm) 2 pcs
- 6.4.6 Bidet Head with 1.2 m PVC Hose w/ Holder 2 pcs
- 6.4.7 Faucet Lever Type 6 pcs
- 6.4.8 Urinal Flush Valve, Push Type 6 pcs
- 6.4.8 Flexible Hose 24" 2 pcs

- 6.4.9 3-way Angle Valve 1/2" Ø ABS Chrome 2 pcs
- 6.4.10 Angle Control Valve 1/2" Ø ABS Chrome 2 pcs

#### 6.5 Rehabilitation of Septic Tank

- 6.5.1 Rehabilitation of Common Public C.R. Septic Tank 1 lot
- 6.5.2 Siphoning of Septic Tank 1 lot

Sub-total, 6.0 (Plumbing Works)

#### 7.0 ELECTRICAL WORKS

##### 7.1 Lighting and Outlet Fixtures

- 7.1.1 2-20w (30cm x 120cm) Surface Mounted Troffer Fixture with 2pcs. LED Tubes 10 set
- 7.1.2 (115 mm x 85mm x 115mm) LED Wall Mounted Light 3W Warmlight 4 set
- 7.1.3 LED Track Light Economy COB Type Black Round 10W 12W 15W 2 pcs
- 7.1.4 4' Fluorescent LED Tube W/ Tube Housing 2 set

##### 7.2 WIRES AND CABLES

- 7.2.1 5.5 mm<sup>2</sup> THHN Stranded 50 m
- 7.2.2 3.5 mm<sup>2</sup> THHN Stranded 80 m

##### 7.3 CONDUITS

- 7.3.1 Junction Box (Octagonal) 10 pcs
- 7.3.2 Utility Box 4 pcs
- 7.3.3 1" Ø Elec. PVC Pipe 10 lght
- 7.3.4 PVC Connector 1" 6 pcs
- 7.3.5 PVC Elbow 1" Ø 6 pcs
- 7.3.6 EMT Elbow 1 1/2" Ø 10 pcs
- 7.3.7 EMT Elec. Pipe 1 1/2" Ø 10 lght
- 7.3.8 EMT Elec. Connector 1 1/2" Ø 10 pcs
- 7.3.9 G.I Tie Wire #16 2 kg

Sub-total, 7.0 (Electrical Works)

#### 8.0 PAINTING WORKS

##### 8.1 Surface Preparation and Repainting of Exterior Wall

- 8.1.1 Acrylic Latex Paint Crisp Ecru (Premium) 5 gal
- 8.1.2 Acrylic Latex Paint Cocoa Chips (Premium) 3 gal
- 8.1.3 Acrylic Latex Paint Clear Emulsion (Premium) 2 gal
- 8.1.4 Concrete Putty 2 gal

##### 8.2 Surface Preparation and Repainting of Interior and Exterior Ceiling

- 8.2.1 4 Liters White Permacoat Flat Latex B-701 5 gal
- 8.2.2 Primer Latex Paint White (premium) 2 gal
- 8.2.3 A&B Epoxy Putty 2 gal

##### 8.3 Surface Preparation and Repainting of Interior Walls in Faux Concrete Wall Finished

- 8.3.1 Portland Cement Gray 4 bag
- 8.3.2 White Portland Cement 2 bag
- 8.3.3 High Performance Acrylic Skimcoat 4 gal
- 8.3.4 Acrylic Latex Paint Clear Emulsion (Premium) 4 gal
- 8.3.5 Sandpaper 240 grit 20 pcs

##### 8.4 Repainting of Existing Doors

- 8.4.1 Semi-Gloss Quikc Drying Enamel Paint (Gray) 5 gal
- 8.4.2 Lacquer Thinner 1 gal

Sub-total, 8.0 (Painting Works)

#### 9.0 STEEL WORKS

##### 9.1 Mesh Wire Cover at the Shower Area

- 9.1.1 Angle Bar (1" x 1" x 1/8" x 6m) 5 lght
- 9.1.2 Mesh Wire 2" (4' x 8' x 2.6mm) 3 pcs

Sub-total, 9.0 (Steel Works)

#### 10.0 SUPPLY AND INSTALLATION OF GLASS MIRROR AND STEEL DOOR

##### 10.1 Supply and Installation of Glass Mirrors

- 10.1.1 Mirror w/ Black Aluminum Frame (0.85mx0.40m) 6 set
- 10.1.2 Mirror w/ Black Aluminum Frame (1.88mx0.75m) 2 set

##### 10.2 Supply and Installation of Steel Doors

- 10.2.1 Metal Door and other Accessories (H 2.10m x W 1.00m) (Mid Grey) 4 pcs
- 10.2.2 Door Closer with Standard Arm 4 pcs

Sub-total, 10.0 (Supply and Installation of Glass Mirror and Steel Door)

#### 11.0 MISCELLANEOUS

11.1 FOR ALL OTHER ITEMS that are not included on listed Bill of Quantities in your Bid but are deemed necessary for the completion of the works and the delivery of the project and in full compliance with all the requirements of the occupancy permit. 1 lot

Sub-total, 11.0 (Miscellaneous)

PROJECT DURATION: 60 CALENDAR DAYS

Note: Attach Certificate of Site Inspection

A. TOTAL DIRECT COST



B. CONSUMABLES:  
C. SUPERVISION AND ADMINISTRATION:  
D. TOTAL INDIRECT COST (B+C):  
E. TOTAL COST (A+D)  
F. VAT (12% OF ITEM E):  
GRAND TOTAL OF PROJECT COST:

\*\*\*\*\*NOTHING FOLLOWS\*\*\*\*\*

TOTAL ABC = Php 700,000.00

PROCUREMENT OF LABOR AND MATERIALS FOR THE REPAIR AND CONVERSION OF MALE AND FEMALE TOILETS TO ALL-GENDER COMFORT ROOMS AT ALIJIS CAMPUS/E. SAMSON(GAD Director)

PR# 25-205-0305 03-05-25

MDS 86-101-25-03 03-10-25

**Line Items**

Item No.	Product/Service Name	Description	Quantity	UOM	Budget (PHP)
1	ONE (1) LOT	Labor and Materials for the Repair and Conversion of Male and Female Toilets to All Gender Comfort Rooms at Alijis Campus	1	Lot	700,000.00

**Created by** Rowena De la Vida Prado

**Date Created** 26/03/2025

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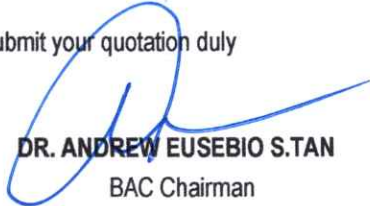
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Mobile Phone Number: 0939 929 6624  
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REQUEST FOR QUOTATION

Date: MARCH 25, 2025  
Quotation No. 25-107

\_\_\_\_\_

Please quote your lowest price on the item/s listed below, stating the shortest time of delivery and submit your quotation duly signed by your representative not later than \_\_\_\_\_ in the return envelope attached herewith.

  
DR. ANDREW EUSEBIO S.TAN  
BAC Chairman

NOTE:

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ITEM NO.	DESCRIPTION OF WORKS	QTY.	UNIT	MATERIAL COST		LABOR COST		TOTAL COST
				Unit Cost	Material Sub-Total Cost	Unit Cost	Labor Sub-Total Cost	
	ONE (1) LOT							
	LABOR AND MATERIALS FOR THE REPAIR AND CONVERSION OF MALE AND FEMALE TOILETS TO ALL-GENDER COMFORT ROOMS AT ALIJIS CAMPUS							
	SCOPE OF WORKS							
1.0	GENERAL WORKS							
1.1	Chipping of Slab and Wall Tiles (Affected Portion)							
1.2	Hauling of Waste Materials							
1.3	Clearing, Hauling, and Cleaning of site							
2.0	CARPENTRY WORKS							
2.1	Phenolic Shelves, Urinal and Toilet Partitions							
2.2	Signage							
3.0	ROOFING WORKS							
3.1	End Flashing							
4.0	MASONRY WORKS							
4.1	Construction of Footwash, Expansion on Bath Canal and Tubular Steel Base Cement Cover							

Released (BAC) \_\_\_\_\_ Date \_\_\_\_\_ By \_\_\_\_\_  
Returned (Supplier) \_\_\_\_\_

\_\_\_\_\_  
Printed Name/Signature  
\_\_\_\_\_  
Tel. No./Cellphone No.  
\_\_\_\_\_  
Date



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**REQUEST FOR QUOTATION**


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ITEM NO.	DESCRIPTION OF WORKS	QTY.	UNIT	MATERIAL COST		LABOR COST		TOTAL COST
				Unit Cost	Material Sub-Total Cost	Unit Cost	Labor Sub-Total Cost	
4.2	Concrete Door Jamb							
5.0	<b>TILE WORKS</b>							
5.1	Installation of Wall Tiles							
5.2	Installation of Floor Tiles							
5.3	Installation of Countertop Lavatory Tiles							
6.0	<b>PLUMBING WORKS</b>							
6.1	Installation of Soil Pipe							
6.2	Installation of Waste Pipe							
6.3	Installation of Water Supply Line							
6.4	Installation of Plumbing Fixtures							
6.5	Rehabilitation of Septic Tank							
7.0	<b>ELECTRICAL WORKS</b>							
7.1	Lighting and Outlet Fixtures							
7.2	Wires and Cables							
7.3	Conduits							
8.0	<b>PAINTING WORKS</b>							
8.1	Surface Preparation and Repainting of Exterior Walls							

Date \_\_\_\_\_ By \_\_\_\_\_

Released (BAC) \_\_\_\_\_

Returned (Supplier) \_\_\_\_\_

\_\_\_\_\_  
Printed Name/Signature
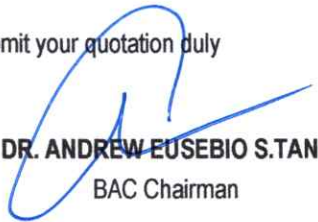
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Tel. No./Cellphone No.

\_\_\_\_\_  
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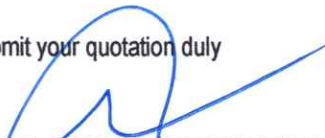
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8.2	Surface Preparation and Repainting of Interior and Exterior Ceiling							
8.3	Surface Preparation and Repainting of Interior Walls in Faux Concrete Wall Finished							
8.4	Repainting of Existing Door							
9.0	<b>STEEL WORKS</b>							
9.1	Mesh Wire Cover at the Shower Area							
10.0	<b>SUPPLY AND INSTALLATION OF GLASS MIRROR AND STEEL DOOR</b>							
10.1	Supply and Installation of Glass Mirrors							
10.2	Supply and Installation of Steel Doors							
11.0	<b>MISCELLANEOUS</b>							
11.1	FOR ALL OTHER ITEMS that are not included on listed Bill of Quantities in your Bid but are deemed necessary for the completion of the works and the delivery of the project and in full compliance with all the requirements of the occupancy permit.							

Date \_\_\_\_\_ By \_\_\_\_\_

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Returned (Supplier) \_\_\_\_\_

\_\_\_\_\_  
Printed Name/Signature

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Tel. No./Cellphone No.

\_\_\_\_\_  
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	Note: All Design & Plans Should be referred to the identified parameters.							
	<b>BILL OF QUANTITIES</b>							
1.0	<b>GENERAL WORKS</b>							
1.1	Chipping of Slab and Wall Tiles (Affected Portion)	1	lot					
1.2	Hauling of waste materials	1	lot					
1.3	Clearing, Hauling, and Cleaning of site	1	lot					
	<b>Sub-total, 1.0 (General Works)</b>							
2.0	<b>CARPENTRY WORKS</b>							
2.1	<b>Phenolic Shelves, Urinal and Toilet Partitions</b>							
2.1.1	Solid and Compacted Phenolic Board Shelf (4' x 8' x 3/4" thick)	8	set					
2.1.2	Edging Strip 3/4" (Walnut)	20	m					
2.1.3	Black Aluminum U-Channel 3/4" (2m)	6	lght					
2.2	<b>Signage</b>							
2.2.1	Laminated Wood Signage w/ Metal Frame Set	2	set					
	<b>Sub-total, 2.0 (Carpentry Works)</b>							

Date

By

Released (BAC)

Returned (Supplier)

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## REQUEST FOR QUOTATION

Page 5 of 14

Date: MARCH 25, 2025

Quotation No. 25-107

Please quote your lowest price on the item/s listed below, stating the shortest time of delivery and submit your quotation duly signed by your representative not later than \_\_\_\_\_ in the return envelope attached herewith.

**DR. ANDREW EUSEBIO S.TAN**  
BAC Chairman

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				Unit Cost	Material Sub-Total Cost	Unit Cost	Labor Sub-Total Cost	
<b>3.0</b>	<b>ROOFING WORKS</b>							
<b>3.1</b>	<b>End Flashing</b>							
3.1.1	Pre-painted Flashing GA 24 (0.7mm x 2.44m)	15	ln.m.					
3.1.2	Angle Bar ( 1" x 1 1/2" x 1/8" x 6m)	5	lght					
3.1.3	10mm Ø DSB	5	lght					
	<b>Sub-total, 3.0 (Roofing Works)</b>							
<b>4.0</b>	<b>MASONRY WORKS</b>							
<b>4.1</b>	<b>Construction of Footwash, Expansion of Bath Canal and Tubular Steel Base Cement Cover</b>							
4.1.1	Portland Cement	5	bag					
4.1.2	Sand	1	cu.m.					
4.1.3	Gravel (3\4)	1	cu.m.					
4.1.4	10mm Ø DSB	4	lght					
4.1.5	Tie Wires	1	K					
<b>4.2</b>	<b>Concrete Door Jamb</b>							
4.2.1	Portland Cement (40kg)	5	bag					

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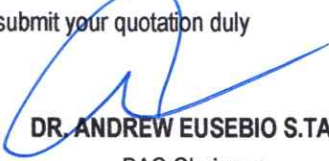
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4.2.2	Concrete Accelerating Admixture	5	bag					
4.2.3	Mixing Sand	1	cu.m					
4.2.4	8 mm ø x 6 m DSB	12	lght					
4.2.5	10 mm ø x 6 m DSB	8	lght					
4.2.6	#16 G.I. Tie Wires	6	kg					
	<b>Sub-total, 4.0 (Masonry Works)</b>							
<b>5.0</b>	<b>TILE WORKS</b>							
<b>5.1</b>	<b>Installation of Wall Tiles</b>							
5.1.1	16"x16" Wood Cream, Floor Tiles	320	pcs					
5.1.2	12"x12" Vienne Charcoal, Wall Tiles	20	pcs					
5.1.3	Portland Cement	11	bag					
5.1.4	ABC Tile Adhesive	15	bag					
5.1.5	Tile Grout	8	kg					
<b>5.2</b>	<b>Installation of Floor Tiles</b>							
5.2.1	16"x16" Yale Dark, Floor Tiles	100	pcs					
5.2.2	Portland Cement	4	bag					
5.2.3	ABC Tile Adhesive	4	bag					

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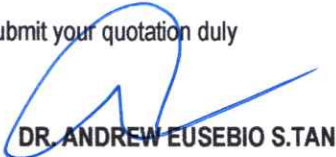


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				Unit Cost	Material Sub-Total Cost	Unit Cost	Labor Sub-Total Cost	
5.2.4	Tile Grout	5	kg					
5.2	<b>Installation of Countertop Lavatory Tiles</b>							
5.2.1	16"x16" Black Pearl Granite Tiles	15	pcs					
	<b>Sub-total, 5.0 (Tile Works)</b>							
6.0	<b>PLUMBING WORKS</b>							
6.1	<b>Installation of Soil Pipe</b>							
6.1.1	PVC Sanitary Pipe (Orange Pipe) 6"Ø x 10'ft.	5	lght					
6.1.2	Watercloset PVC Bend Fittings 6" x 6"	2	pcs					
6.1.3	PVC Wye 6" x 6"	2	pcs					
6.1.5	Pvc Sanitary fittings Elbow 90 degrees 1/4 bend 6"Ø	4	pcs					
6.1.6	PVC Sanitary Clean out 6"	5	pcs					
6.1.7	PVC Coupling Sanitary Fitting 6"	4	pcs					
6.1.8	PVC Reducer Sanitary Fitting 4"-6"	4	pcs					
6.1.9	P-trap set 1-1/2	8	pcs					

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
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				Unit Cost	Material Sub-Total Cost	Unit Cost	Labor Sub-Total Cost	
<b>6.2</b>	<b>Installation of Waste Pipe</b>							
6.2.1	PVC Sanitary Pipe (Orange Pipe) 2"Ø	7	lght					
6.2.2	PVC Sanitary Pipe (Orange Pipe) 4"Ø	10	lght					
6.2.3	Wye Reducer 4" x 2"	22	pcs					
6.2.4	PVC Coupling Sanitary Fitting 2"	4	pcs					
6.2.5	PVC Sanitary Clean out 2"	2	pcs					
6.2.6	Sanitary P-Trap 2"	1	pcs					
6.2.7	Floor Drain 4"x4"	2	pcs					
<b>6.3</b>	<b>Installation of Water Supply Line</b>							
6.3.1	PE Pipe to PVC connector 3/4" Ø	2	pcs					
6.3.2	PVC Pipe 3/4" Ø (Blue Pipe)	8	lght					
6.3.3	PVC Pipe 1/2" Ø (Blue Pipe)	4	lght					
6.3.4	PVC Fittings Elbow 45 Degrees 1/2"	4	pcs					
6.3.5	PVC Reducer 3/4" to 1/2"Ø	2	pcs					
6.3.6	PVC Coupling Tee 3/4"	4	pcs					
6.3.7	PVC Fittings Tee 1/2"	4	pcs					
6.3.8	PVC Gate Valve 1/2"	1	pcs					
6.3.9	PVC Gate Valve 3/4"	1	pcs					

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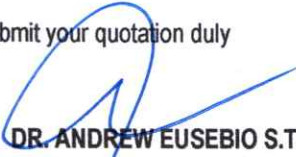


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				Unit Cost	Material Sub-Total Cost	Unit Cost	Labor Sub-Total Cost	
6.4	Installation of Plumbing Fixtures							
6.4.1	Two Piece Water Closet	11	pcs					
6.4.3	Square Vessel Basin (370 x 480 x 130mm)	2	pcs					
6.4.4	U Shaped Handicap Grab Bar (600mm-750mm)	2	pcs					
6.4.5	2 Walls Stainless Steel Angled Grab Bar w/ Snap Flange Bobrick (750 x 1000mm)	2	pcs					
6.4.6	Bidet Head with 1.2 m PVC Hose w/ Holder	2	pcs					
6.4.7	Faucet Lever Type	6	pcs					
6.4.8	Urinal Flush Valve, Push Type	6	pcs					
6.4.8	Flexible Hose 24"	2	pcs					
6.4.9	3-way Angle Valve 1/2" ø ABS Chrome	2	pcs					
6.4.10	Angle Control Valve 1/2" ø ABS Chrome	2	pcs					
6.5	Rehabilitation of Septic Tank							
6.5.1	Rehabilitation of Common Public C.R. Septic Tank	1	lot					
6.5.2	Siphoning of Septic Tank	1	lot					
	Sub-total, 6.0 (Plumbing Works)							

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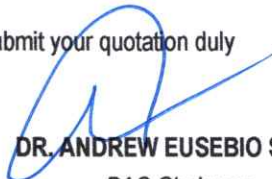


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7.0	<b>ELECTRICAL WORKS</b>							
7.1	<b>Lighting and Outlet Fixtures</b>							
7.1.1	2-20w (30cm x 120cm) Surface Mounted Troffer Fixture with 2pcs. LED Tubes	10	set					
7.1.2	(115 mm x 85mm x 115mm) LED Wall Mounted Light 3W Warmlight	4	set					
7.1.3	LED Track Light Economy COB Type Black Round 10W 12W 15W	2	pcs					
7.1.4	4' Fluorescent LED Tube W/ Tube Housing	2	set					
7.2	<b>WIRES AND CABLES</b>							
7.2.1	5.5 mm <sup>2</sup> THHN Stranded	50	m					
7.2.2	3.5 mm <sup>2</sup> THHN Stranded	80	m					
7.3	<b>CONDUITS</b>							
7.3.1	Junction Box (Octagonal)	10	pcs					
7.3.2	Utility Box	4	pcs					
7.3.3	1" Ø Elec. PVC Pipe	10	lght					
7.3.4	PVC Connector 1"	6	pcs					
7.3.5	PVC Elbow 1" Ø	6	pcs					

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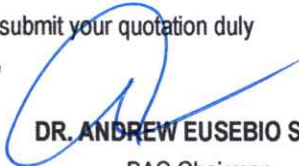


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7.3.6	EMT Elbow 1 1/2" Ø	10	pcs					
7.3.7	EMT Elec. Pipe 1 1/2" Ø	10	lght					
7.3.8	EMT Elec. Connector 1 1/2" Ø	10	pcs					
7.3.9	G.I Tie Wire #16	2	kg					
	<b>Sub-total, 7.0 (Electrical Works)</b>							
8.0	<b>PAINTING WORKS</b>							
8.1	<b>Surface Preparation and Repainting of Exterior Wall</b>							
8.1.1	Acrylic Latex Paint Crisp Ecru (Premium)	5	gal					
8.1.2	Acrylic Latex Paint Cocoa Chips (Premium)	3	gal					
8.1.3	Acrylic Latex Paint Clear Emulsion (Premium)	2	gal					
8.1.4	Concrete Putty	2	gal					
8.2	<b>Surface Preparation and Repainting of Interior and Exterior Ceiling</b>							
8.2.1	4 Liters White Permacoat Flat Latex B-701	5	gal					
8.2.2	Primer Latex Paint White (premium)	2	gal					
8.2.3	A&B Epoxy Putty	2	gal					

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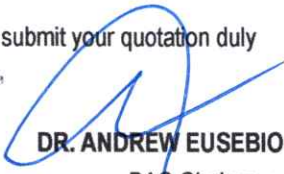


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8.3	Surface Preparation and Repainting of Interior Walls in Faux Concrete Wall							
8.3.1	Portland Cement Gray	4	bag					
8.3.2	White Portland Cement	2	bag					
8.3.3	High Performance Acrylic Skimcoat	4	gal					
8.3.4	Acrylic Latex Paint Clear Emulsion (Premium)	4	gal					
8.3.5	Sandpaper 240 grit	20	pcs					
8.4	Repainting of Existing Doors							
8.4.1	Semi-Gloss Quick Drying Enamel Paint (Gray)	5	gal					
8.4.2	Lacquer Thinner	1	gal					
	Sub-total, 8.0 (Painting Works)							
9.0	STEEL WORKS							
9.1	Mesh Wire Cover at the Shower Area							
9.1.1	Angle Bar (1" x 1" x 1/8" x 6m)	5	lght					
9.1.2	Mesh Wire 2" (4' x 8' x 2.6mm)	3	pcs					
	Sub-total, 9.0 (Steel Works)							

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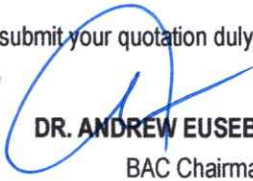


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  - 5. G-EPS REGISTRATION CERTIFICATE SHALL BE ATTACHED UPON SUBMISSION OF THE QUOTATION
  - 6. BIDDERS SHALL SUBMIT ORIGINAL BROCHURES SHOWING CERTIFICATIONS OF THE PRODUCT BEING OFFERED

ITEM NO.	DESCRIPTION OF WORKS	QTY.	UNIT	MATERIAL COST		LABOR COST		TOTAL COST
				Unit Cost	Material Sub-Total Cost	Unit Cost	Labor Sub-Total Cost	
10.0	<b>SUPPLY AND INSTALLATION OF GLASS MIRROR AND STEEL DOOR</b>							
10.1	<b>Supply and Installation of Glass Mirrors</b>							
10.1.1	Mirror w/ Black Aluminum Frame (0.85mx0.40m)	6	set					
10.1.2	Mirror w/ Black Aluminum Frame (1.88mx0.75m)	2	set					
10.2	<b>Supply and Installation of Steel Doors</b>							
10.2.1	Metal Door and other Accessories (H 2.10m x W 1.00m) (Mid Grey)	4	pcs					
10.2.2	Door Closer with Standard Arm	4	pcs					
	<b>Sub-total, 10.0 (Supply and Installation of Glass Mirror and Steel Door)</b>							
11.0	<b>MISCELLANEOUS</b>							
11.1	FOR ALL OTHER ITEMS that are not included on listed Bill of Quantities in your Bid but are deemed necessary for the completion of the works and the delivery of the project and in full compliance with all the requirements of the occupancy permit.	1	lot					
	<b>Sub-total, 11.0 (Miscellaneous)</b>							

Date \_\_\_\_\_ By \_\_\_\_\_  
Released (BAC) \_\_\_\_\_  
Returned (Supplier) \_\_\_\_\_

\_\_\_\_\_  
Printed Name/Signature  
\_\_\_\_\_  
Tel. No./Cellphone No.  
\_\_\_\_\_  
Date





Republic of the Philippines  
**CARLOS HILADO MEMORIAL STATE UNIVERSITY**  
Talisay City, Negros Occidental  
Mobile Phone Number: 0939 929 6624  
[bac.sec@chmsu.edu.ph](mailto:bac.sec@chmsu.edu.ph)

**REQUEST FOR QUOTATION**


Page 14 of 14

Date: MARCH 25, 2025  
Quotation No. 25-107

\_\_\_\_\_

\_\_\_\_\_

Please quote your lowest price on the item/s listed below, stating the shortest time of delivery and submit your quotation duly signed by your representative not later than \_\_\_\_\_ in the return envelope attached herewith.

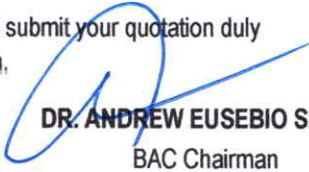  
**DR. ANDREW EUSEBIO S.TAN**  
BAC Chairman

**NOTE:**

- 1. ALL ENTRIES MUST BE TYPEWRITTEN
- 2. DELIVERY PERIOD WITHIN 60 CALENDAR DAYS
- 3. WARRANTY SHALL BE FOR A PERIOD OF SIX (6) MONTHS FOR SUPPLIES & MATERIALS, ONE (1) YEAR FOR EQUIPMENT, FROM DATE OF OF ACCEPTANCE BY THE PROCURING ENTITY
- 4. PRICE VALIDITY SHALL BE FOR A PERIOD OF \_\_\_\_\_ CALENDAR DAYS
- 5. G-EPS REGISTRATION CERTIFICATE SHALL BE ATTACHED UPON SUBMISSION OF THE QUOTATION
- 6. BIDDERS SHALL SUBMIT ORIGINAL BROCHURES SHOWING CERTIFICATIONS OF THE PRODUCT BEING OFFERED

ITEM NO.	DESCRIPTION OF WORKS	QTY.	UNIT	MATERIAL COST		LABOR COST		TOTAL COST
				Unit Cost	Material Sub-Total Cost	Unit Cost	Labor Sub-Total Cost	
	PROJECT DURATION: 60 CALENDAR DAYS							
	Note: Attach Certificate of Site Inspection							
	<b>A. TOTAL DIRECT COST</b>							
	<b>B. CONSUMABLES:</b>							
	<b>C. SUPERVISION AND ADMINISTRATION:</b>							
	<b>D. TOTAL INDIRECT COST (B+C):</b>							
	<b>E. TOTAL COST (A+D)</b>							
	<b>F. VAT (12% OF ITEM E):</b>							
	<b>GRAND TOTAL OF PROJECT COST:</b>							
	<b>*****NOTHING FOLLOWS*****</b>							
	<b>TOTAL ABC = Php 700,000.00</b>							
	<b>PROCUREMENT OF LABOR AND MATERIALS FOR THE REPAIR AND CONVERSION OF MALE AND FEMALE TOILETS TO ALL-GENDER COMFORT ROOMS AT ALIJIS CAMPUS/E. SAMSON(GAD Director)</b>							
	<b>PR# 25-205-0305 03-05-25</b>							
	<b>MDS 86-101-25-03 03-10-25</b>							

Date \_\_\_\_\_ By \_\_\_\_\_

Released (BAC) \_\_\_\_\_

Returned (Supplier) \_\_\_\_\_

\_\_\_\_\_  
Printed Name/Signature

\_\_\_\_\_  
Tel. No./Cellphone No.

\_\_\_\_\_  
Date





MALE COMFORT ROOM

SYMBOLS	DESCRIPTION
A	Mirror w/ Aluminum Frame (0.85m x 0.40m)
B	Lever Type Faucet (See Material Spec.)
C	Black Pearl Counter Top (See Material Spec.)
D	Square Vessel Basin (See Material Spec.)
E	4' Fluorescent LED Tube w/ Tube Housing
F	Faux Concrete Wall Finish
G	Acrylic Latex Paint Faint Silver Ceiling Paint (See Material Spec.)
H	(115 x 85 x 115 mm) LED Wall Mounted Light 3w Warmlight
I	Wall Mounted Urinal
J	Toilet Lavatory (0.30m x 0.40m) White
K	Phenolic Board Shelf










URINAL AREA



MALE PWD TOILET

PERSPECTIVE (MALE COMFORT ROOM)

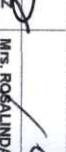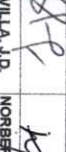	Republic of the Philippines CARLOS HILADO MEMORIAL STATE UNIVERSITY Negros Occidental	PROJECT TITLE: REPAIR AND CONVERSION OF MALE AND FEMALE TOILETS TO ALL - GENDER COMFORT ROOMS	ENDORSED BY: 	ENDORSED BY: 	CHECKED BY: 	RECOMMENDING APPROVAL: 	APPROVED: 	PREPARED / CHECKED BY: 	SHEET NO. C	PAGE NO. S			
PROJECT LOCATION: ALLIS CAMPUS, BACOLOD CITY		CAMPUS DIRECTOR DR. EDWIN H. BUGNA		GAD DIRECTOR DR. ELVIE SAMSON		DIRECTOR PDM DR. JUN-JUN MARQUEZ		VICE PRESIDENT FOR ADMINISTRATION MRS. ROSALINDA V. JUVILLA, J.D.		SIC PRESIDENT III NORBERTO MANGULAEN, Ph.D.		FEDERICO T. DENISA JR., Ph.D. CAMPUS PHYSICAL PLANT AND FACILITIES THERESA C. LUNA S. MANCING & GERONA CAMPUS OUTREACH	






FEMALE COMFORT ROOM

SYMBOLS	DESCRIPTION
A	Wall Tile (Viennese Charcoal) 24" x 24"
B	Mirror w/ Aluminum Frame (1.88m x 0.75m)
C	Existing Floor Tiles (Cream White) 24" x 24"
D	Yale Dark, Floor Tiles
E	Square Vessel Basin (See Material Spec.)
F	Mirror w/ Aluminum Frame (0.85m x 0.40m)
G	Troffer Light (See Material Spec.)
H	Two Piece Water Closet
I	Stainless Steel Angled Grab Bar w/ Snap FlangeBobrick (See Material Spec.)
J	"U" Shaped Handicap Grab Bar
K	Toilet Bidet (See Material Spec.)
L	(Wood Cream) Floor Tiles 16"x16"
M	(115 mm x 85mm x 115mm) LED Wall Mounted Light 3W Warmlight
N	Toilet Lavatory (0.30m x 0.40m) White



FEMALE TOILET

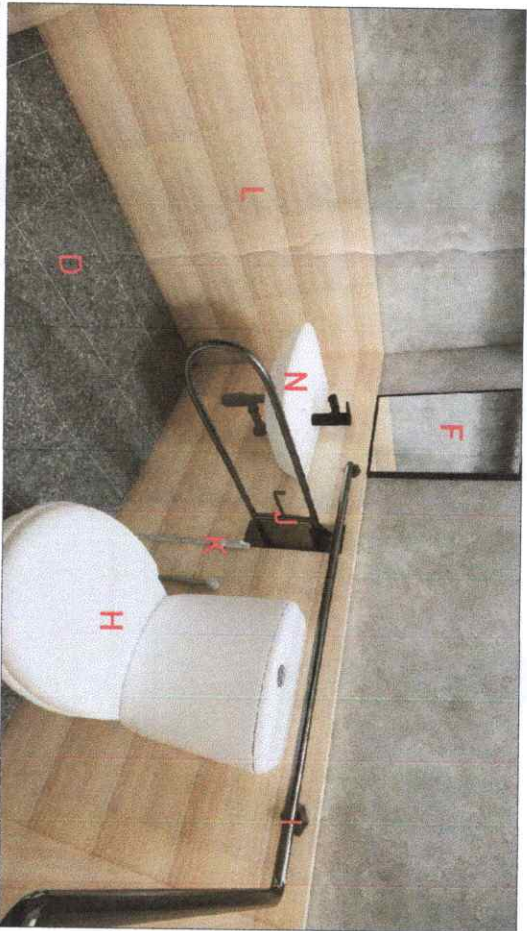

FEMALE PWD TOILET

PERSPECTIVE (FEMALE COMFORT ROOM)



Republic of the Philippines  
CARLOS HILADO MEMORIAL  
STATE UNIVERSITY  
Negros Occidental

PROJECT TITLE:

REPAIR AND CONVERSION OF  
MALE AND FEMALE TOILETS TO  
ALL-GENDER COMFORT ROOMS

ENDORSED BY:

DR. EDWIN H. BUDIA

ENDORSED BY:

DR. ELVIE SAMSON

CHECKED BY:

DR. EDWIN H. BUDIA

RECOMMENDING APPROVAL:

Mrs. ROSALINDA V. DAVILA, J.D.

APPROVED:

NORBERTO M. MANGULABNAN, Ph.D.

PREPARED / CHECKED BY:

FEDERICK DENISA JR., Ph.D.  
CAMPUS PHYSICAL PLANNING FACILITIES  
PLANNING & DESIGN & CONSTRUCTION  
CAMPUS OFF DRAFTSMAN



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PAGE NO.

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







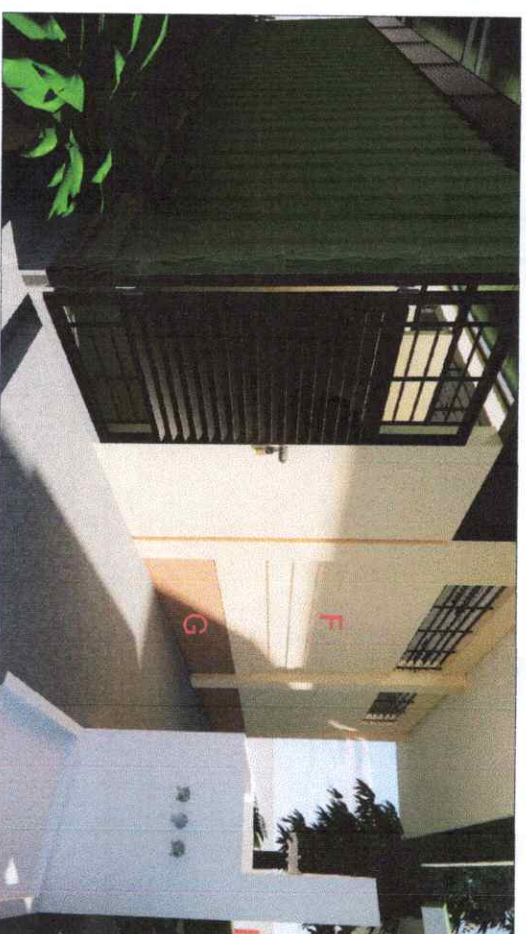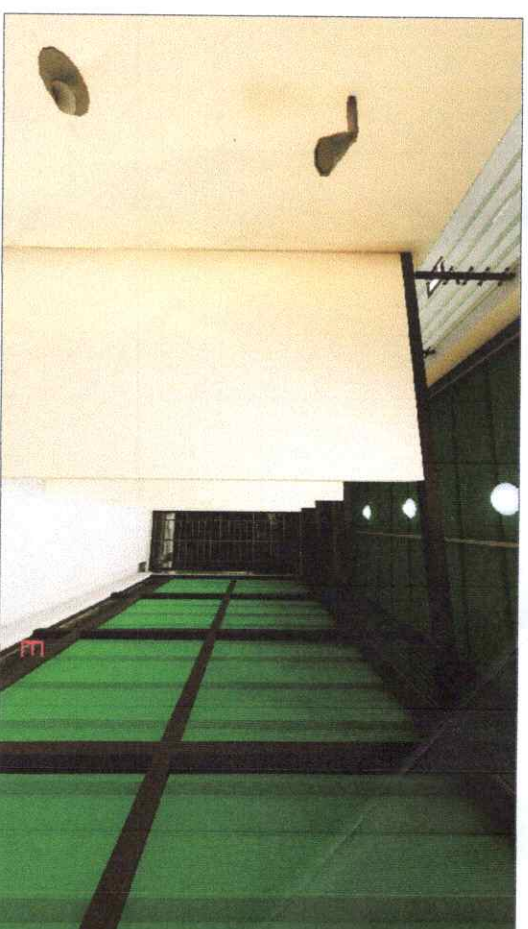

SYMBOLS	DESCRIPTION
A	Male Comfort Room
B	Female Comfort Room
C	Laminated Wood Sillage w/ Metal Frame Set
D	LED Track Light Economy COB Type Black Round
E	Mesh Wire Cover (See Details)
F	Acrylic Latex Paint Crisp Ecru (Premium)
G	Acrylic Latex Paint Cocoa Chips (Premium)




## COMFORT ROOM PERSPECTIVE

	
Republic of the Philippines <b>CARLOS HILADO MEMORIAL</b> STATE UNIVERSITY Negros Occidental	
PROJECT TITLE:	REPAIR AND CONVERSION OF MALE AND FEMALE TOILETS TO ALL - GENDER COMFORT ROOMS
ENDORSED BY:	 DR. EDWIN H. BUGNA CAMPUS DIRECTOR
ENDORSED BY:	 DR. ELVIE SAMSON GAD DIRECTOR
CHECKED BY:	 ENGR. JUN-JUN MARCANO DIRECTOR PPDM
RECOMMENDING APPROVAL:	 MR. ROSALINDA P. TUVILLA, J.D. VICE PRESIDENT FOR ADMINISTRATION
APPROVED:	 NORBERTO P. MANAULA VICE PRESIDENT III
PREPARED / CHECKED BY:	FEDERICO DENISA JR., P.H.D. CAMPUS PHYSICAL PLANNING AND FACILITIES PROJECTING & DESIGN & DRAWING & CAMPAIGN CAMPUS OUT DRAFTSMAN
SHEET NO.	PAGE NO.



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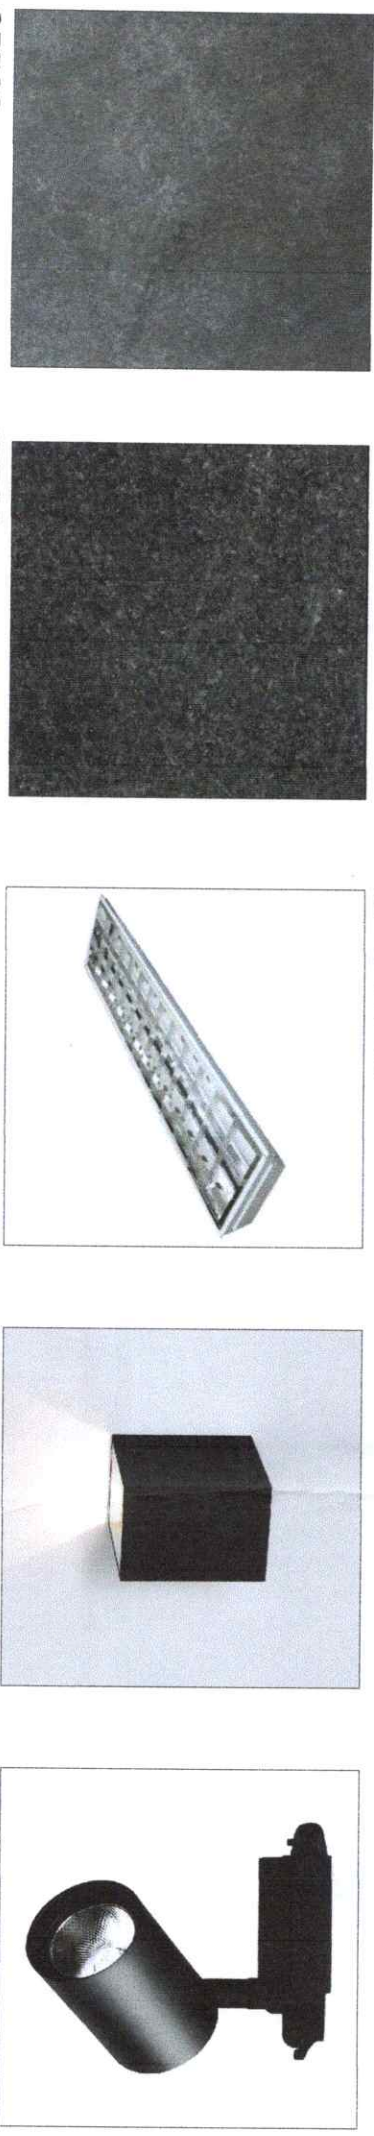
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

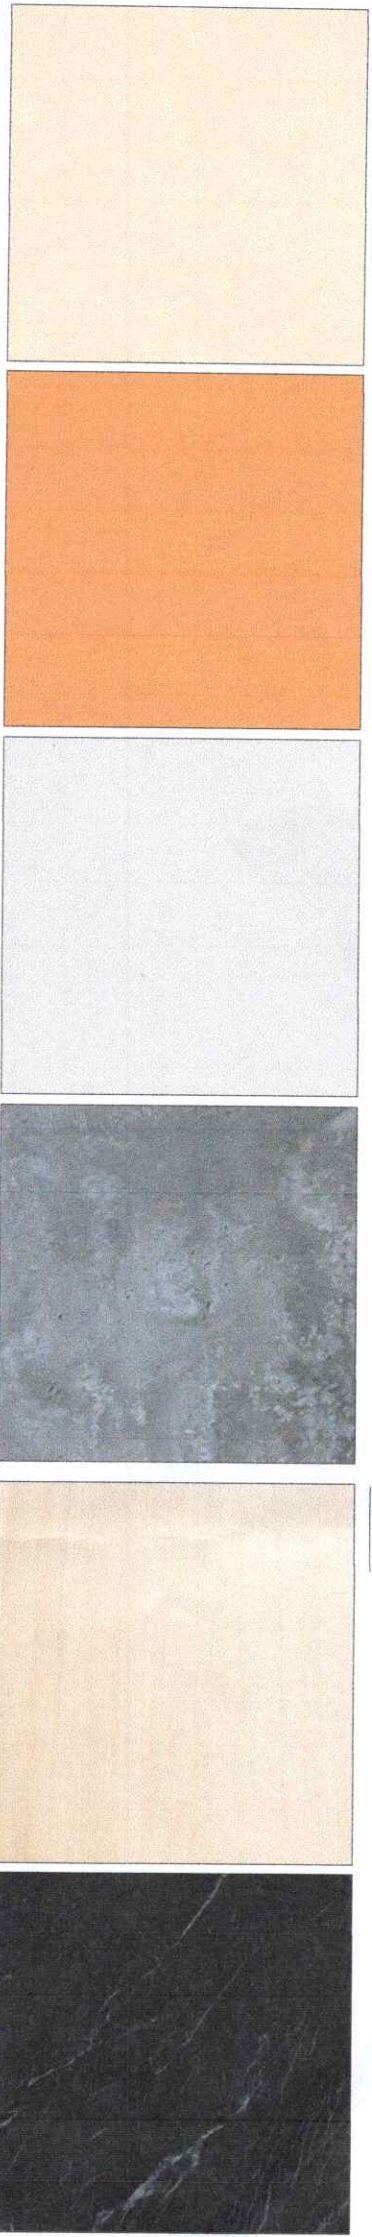




SPECS: Acrylic Latex Paint Crisp Ecru (Premium) LOCATION: Wall Paint  
SPECS: Acrylic Latex Paint Cocoa Chips (Premium) LOCATION: Wall Paint  
SPECS: Acrylic Latex Paint Faint Silver (Premium) LOCATION: Ceiling Paint  
SPECS: Faux Concrete Wall Finish LOCATION: Wall Paint  
SPECS: Tiles (Wood Cream) 24" x 24" LOCATION: Wall Tiles  
SPECS: Tiles (Vienne Charcoal) 24" x 24" LOCATION: Wall Tiles

TILES

LIGHTTHINGS

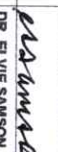

SPECS: Tiles (Yale Dark) 16" x 16" LOCATION: Toilet  
SPECS: Black Pearl Granite Countertop LOCATION: Lavatory  
SPECS: 2-20w (30cm x 120cm) Surface Mounted Troffer w/ 2pcs. LED Tubes LOCATION: Ceiling  
SPECS: (115 x 85 x 115 mm) LED Surface/Mounted Panel Light 3w Warmlight LOCATION: Mirror Accent Light  
SPECS: LED Track Light Economy COB Type Black Round LOCATION: Metal Signage

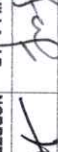
	Republic of the Philippines CARLOS HILADO MEMORIAL STATE UNIVERSITY Negros Occidental		PROJECT TITLE: REPAIR AND CONVERSION OF MALE AND FEMALE TOILETS TO ALL - GENDER COMFORT ROOMS		ENDORSED BY:  DR. EDWIN H. BUJANA CAMPUS DIRECTOR	ENDORSED BY:  DR. ELVIE SAMSON CAMPUS DIRECTOR	CHECKED BY:  DR. JUN-JUN MAGALLANES DIRECTOR FROM	RECOMMENDING APPROVAL:  MRS. ROSALINDA V. TUVILLA, J.D. VICE PRESIDENT FOR ADMINISTRATION	APPROVED:  NORBERTO P. MANGULABNAN, Ph.D. SUC PRESIDENT	PREPARED / CHECKED BY:  FEDERICO V. DENISA, JR., Ph.D. CAMPUS PHYSICAL PLANT AND FACILITIES MANAGEMENT DIVISION CAMPUS OUTREACH DIVISION	SHEET NO. 1	PAGE NO.
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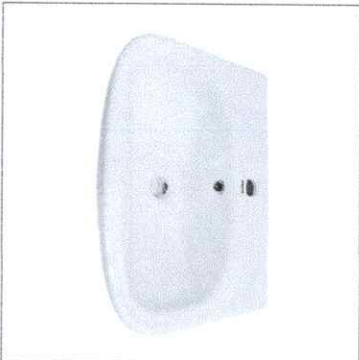
MATERIAL SPECIFICATION



SPECS: Two Piece Water Closet  
(White)  
LOCATION: PWD & Toilet




SPECS: Square Vessel Basin  
(370 x 480 x 130mm)  
LOCATION: Lavatory

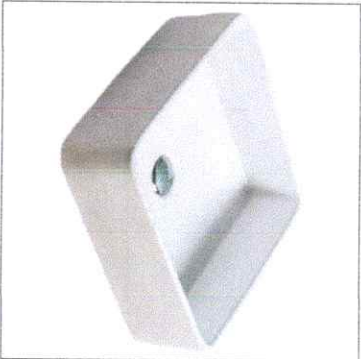

SPECS: Toilet Lavatory  
(0.30 x 0.40m) White  
LOCATION: PWD Toilet



SPECS: Bidet Head with 1.2m  
PVC Hose w/ Holder  
LOCATION: PWD Toilet

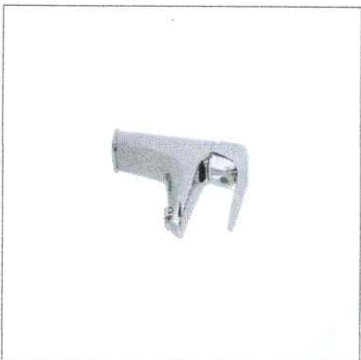

SPECS: Faucet Lever Type  
LOCATION: Lavatory




SPECS: Urinal Flush Valve, Push Type  
LOCATION: Urinal



SPECS: 2 Walls Stainless Steel Angled Grab Bar w/ Snap Flange Bobrick (750 x 100mm)  
LOCATION: Lavatory



SPECS: U Shaped Handicap Grab  
Bar (600mm x 750mm)  
LOCATION: PWD Toilet

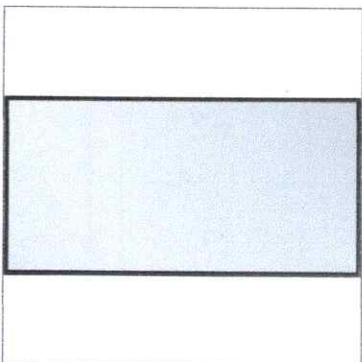

SPECS: Mirror w/ Black Aluminium  
Frame (0.85m x 0.40m)  
LOCATION: Lavatory, PWD Toilet

	
Republic of the Philippines CARLOS HILADO MEMORIAL STATE UNIVERSITY Nagpo Occidental	
PROJECT TITLE: REPAIR AND CONVERSION OF MALE AND FEMALE TOILETS TO ALL-GENDER COMFORT ROOMS	
ENDORSED BY: 	ENDORSED BY: 
CAMPUS DIRECTOR	CAMPUS DIRECTOR
CHECKED BY: 	CHECKED BY: 
DIRECTOR PPM	VICE PRESIDENT FOR ADMINISTRATION
RECOMMENDING APPROVAL: 	APPROVED: 
SUC PRESIDE VIII	CAMPUS PHYSICAL PLANNING FACILITIES
	FEDERICO V. DENISA, JR., PH.D.
	FRANCISCO S. JUAN & ASSOCIATES GORONA
	CAMPUS OFF DRAFTSMAN
SHEET NO.	PAGE NO.
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Republic of the Philippines  
CARLOS HILADO MEMORIAL  
STATE UNIVERSITY  
Negros Occidental

PROJECT TITLE:  
REPAIR AND CONVERSION OF  
MALE AND FEMALE TOILETS TO  
ALL - GENDER COMFORT ROOMS

ENDORSED BY:  
DR. EDWIN H. BUGNA  
CAMPUS DIRECTOR

ENDORSED BY:  
DR. ELVIE SAMSON  
GAD DIRECTOR

CHECKED BY:  
DR. JUN-JUN MANCERES  
DIRECTOR PCOM

RECOMMENDING APPROVAL:  
MS. ROSALINDA V. TUVILLA, J.D.  
VICE PRESIDENT FOR ADMINISTRATION

APPROVED:  
NORBERTO R. MANQUILABNAN, Ph.D.  
SUC PRESIDENT III


PREPARED / CHECKED BY:  
FEDERICO V. DENISA JR., Ph.D.  
CAMPUS PHYSICAL PLANT AND FACILITIES  
MANAGEMENT & JEN & JENNIFER S. CERRERA  
CAMPUS OUTREACHMAN

SHEET NO. 1  
PAGE NO. 1

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SCALE

# FLOOR PLAN (COMMON C.R.)

1:100 MTS

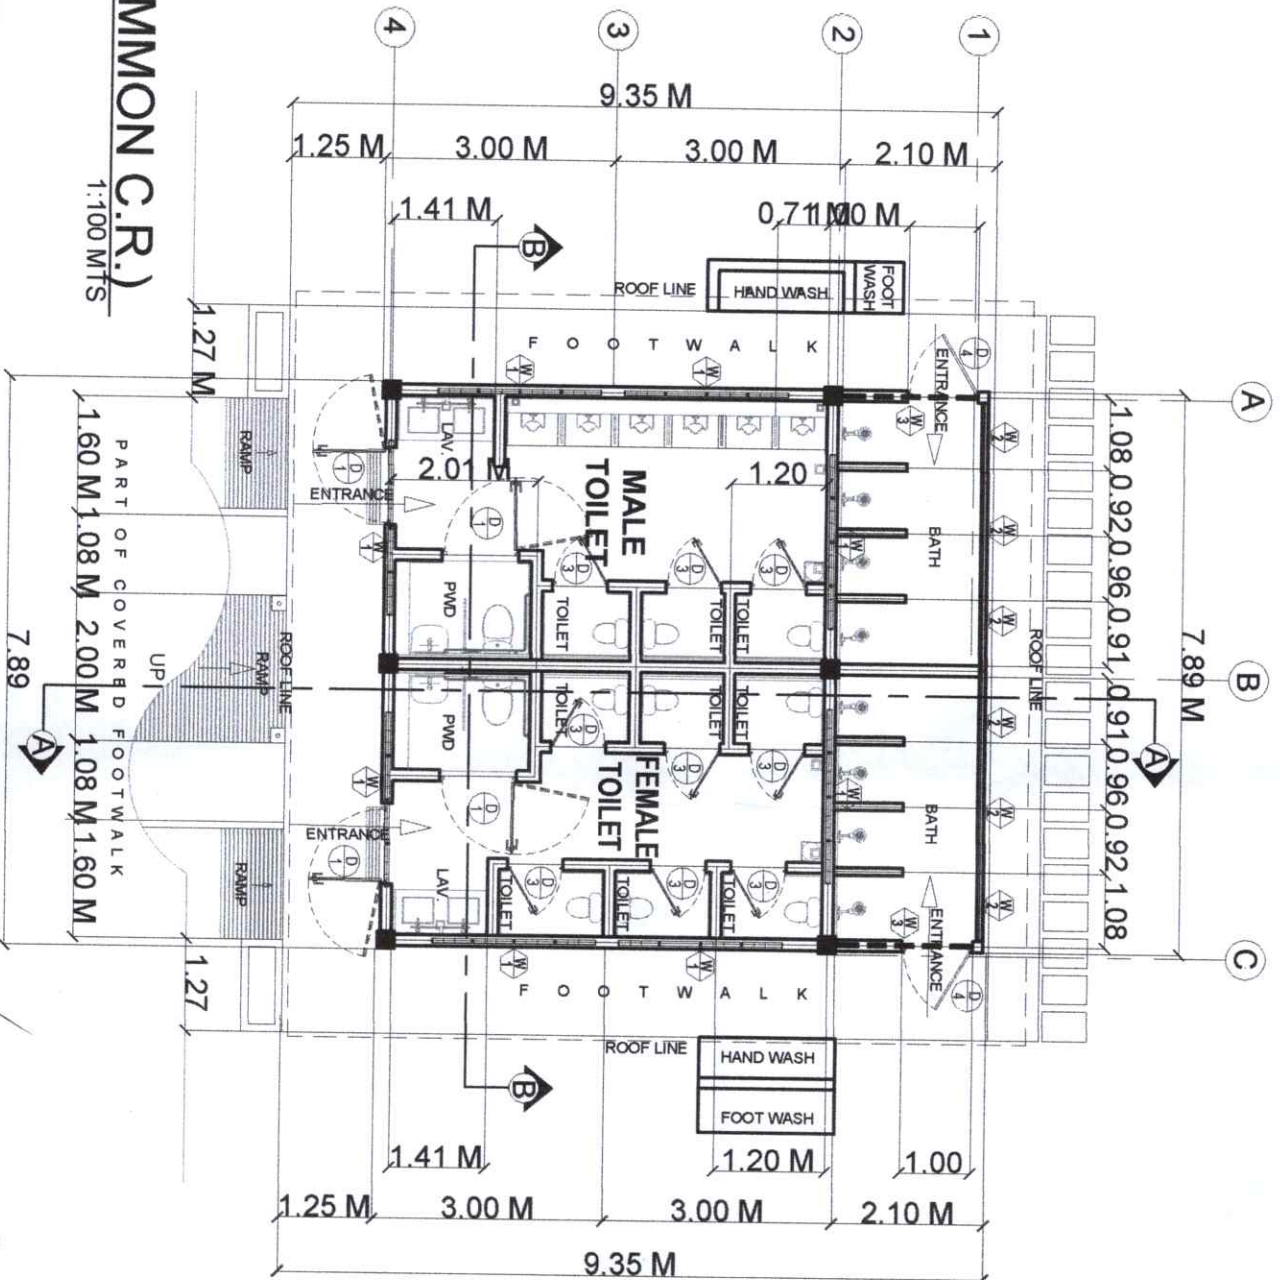





Republic of the Philippines  
CARLOS HILADO MEMORIAL  
STATE UNIVERSITY  
Negros Occidental

PROJECT TITLE:

**ENDORSED BY:**

**ENDORSED BY:**

CHECKED BY:

**Approved:**

[illegible]

1990	1991	1992	2397	2398</
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Architectural section drawing of a building facade. The drawing shows a cross-section with various structural elements and dimensions. Key dimensions include a total width of 4.75, with segments of 0.25, 3.20, and 1.20. Vertical dimensions include 2.10, 0.60, and 0.60. The drawing includes callouts for 'APEX LINE', 'BEAM LINE', and 'EFL' (Finish Floor Line). Section markers A, B, and C are indicated. The drawing also shows existing and proposed elements, including a canopy, window, spot light, paint, concrete cladding, canopy post, door schedule, wall paint (cocoa chips), and hand wash/foot wash.

Dimensions:

- 4.75 (Total width)
- 0.25 (Left segment)
- 3.20 (Middle segment)
- 1.20 (Right segment)
- 2.10 (Vertical dimension)
- 0.60 (Vertical dimension)
- 0.60 (Vertical dimension)

Callouts:

- APEX LINE
- BEAM LINE
- EFL
- NGF
- A
- B
- C
- EXISTING CANOPY
- EXISTING JALOUSIE WINDOW
- WALL MOUNTED SPOT LIGHT (SEE MATERIALS SPEC.)
- WALL PAINT (SEE MATERIALS SPEC.)
- CONCRETE CLADDING
- EXISTING CANOPY POST
- SEE SCHEDULE OF DOORS
- WALL PAINT(COCOA CHIPS) (SEE MATERIALS SPEC.)
- EXISTING HAND WASH & FOOT WASH

FRONT ELEVATION  
1:100 MTS  
A2 SCALE

A2 SCALE

1:100 MTS

2 REAR ELEVATION  
A2 SCALE 1:100 MTS


1:100 MTS

Architectural section drawing of a building facade. The drawing shows a cross-section of a structure with a sloped roof and a vertical wall. Key components and dimensions are labeled:

- Dimensions:**
  - Overall width: 4.75
  - Top horizontal segments: 0.25, 3.20, 1.20
  - Bottom horizontal segments: 0.30, 2.00, 0.40, 0.60
- Labels:**
  - APEX LINE**: Indicated at the top right corner.
  - BEAM LINE**: Indicated at the top center.
  - A, B, C**: Section markers along the top edge.
  - EXISTING ROOFING**: Points to the sloped roof structure.
  - STEEL METAL LOUVER WINDOW (SEE MATERIALS SPEC.)**: Points to the central window assembly.
  - EXISTING METAL SHEET WALL**: Points to the vertical wall section.
  - MESH WIRE COVER (SEE DETAIL)**: Points to a detail on the left side.
  - EXISTING HAND WASH & FOOT WASH**: Points to a detail on the left side.


- EXISTING ROOFING
- STEEL METAL LOUVER WINDOW  
(SEE MATERIALS SPEC.)
- EXISTING METAL SHEET WALL
- MESH WIRE COVER (SEE DETAIL)

- MESH WIRE COVER (SEE DETAIL)
- EXISTING HAND WASH & FOOT WASH

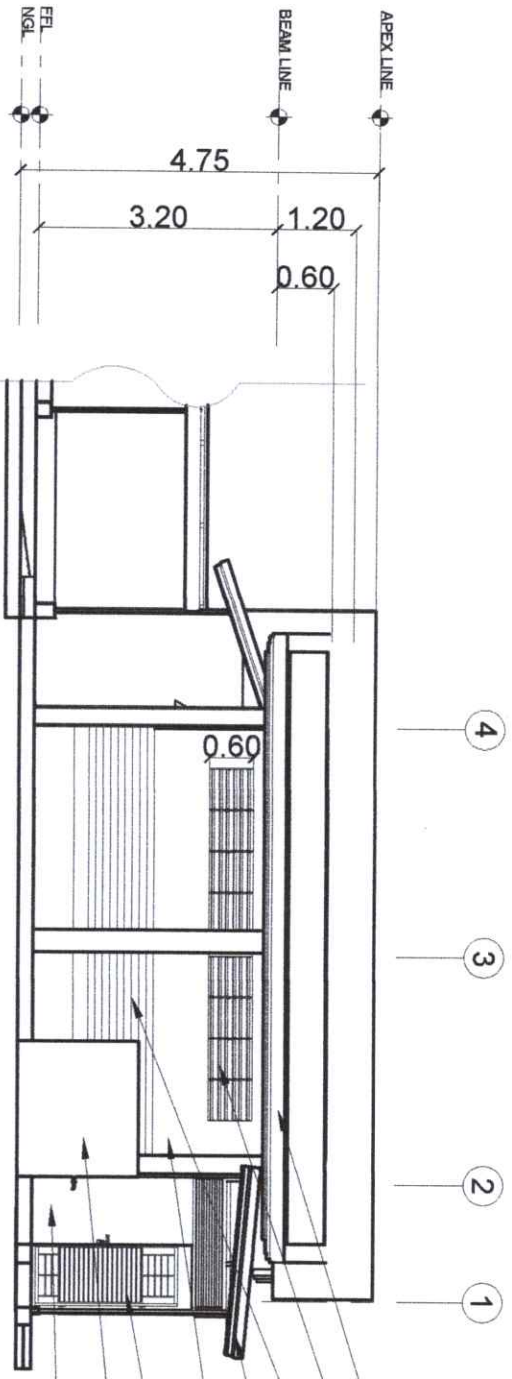


- EXISTING ROOFING
- EXISTING JALOUSIE WINDOW
- CONCRETE CLADDING
- BATH ROOFING
- WALL PAINT (SEE MATERIALS SPEC.)
- EXISTING BATH DOOR
- EXISTING HAND WASH & FOOT WASH
- WALL PAINT(COcoa CHIPS)
- (SEE MATERIALS SPEC.)

1 RIGHT - SIDE ELEVATION  
A3 SCALE  
1:100 MTS

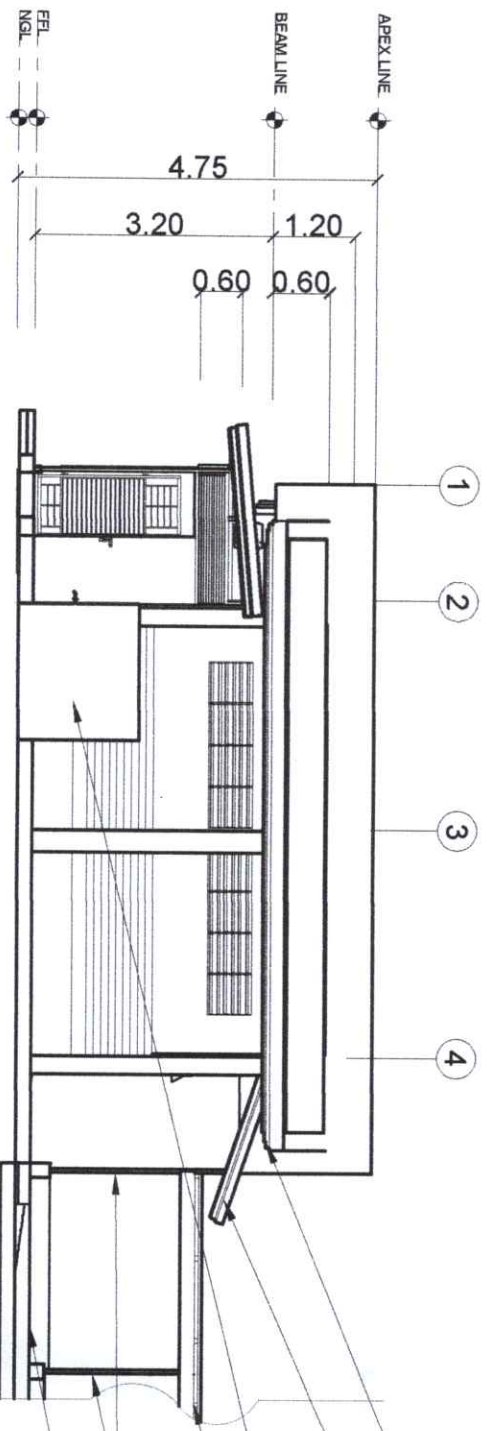


- EXISTING ROOFING
- EXISTING CANOPY ROOFING
- EXISTING HAND WASH & FOOT WASH
- EXISTING CANOPY ROOFING
- EXISTING CANOPY POST
- EXISTING PATHWAY

2 LEFT - SIDE ELEVATION  
A3 SCALE  
1:100 MTS


	
Republic of the Philippines CARLOS HILADO MEMORIAL STATE UNIVERSITY Negros Occidental	
PROJECT TITLE: REPAIR AND CONVERSION OF MALE AND FEMALE TOILETS TO ALL - GENDER COMFORT ROOMS	ENDORSED BY: DR. EDWIN H. BIONA CAMPUS DIRECTOR
PROJECT LOCATION: ALIJS CAMPUS, BACOLOLO CITY	ENDORSED BY: DR. ELVIE SAMSON GAD DIRECTOR
CHECKED BY: ENGR. JUN-JUN MARQUEZ DIRECTOR PDM	RECOMMENDING APPROVAL: MRS. ROSALINDA V. TUVILJA, J.D. VICE PRESIDENT FOR ADMINISTRATION
APPROVED: NORBERTO P. MANGULABNAN, Ph.D. SUC PRESIDENT III	PREPARED / CHECKED BY: FEDERICO V. DENISA JR., P.A.D. CAMPUS PHYSICAL PLANT AND FACILITIES MANAGEMENT, MEAN & PANGLOSS & GARCIA CAMPUS OUTREACH TEAM
SHEET NO. A 3	PAGE NO. A 3



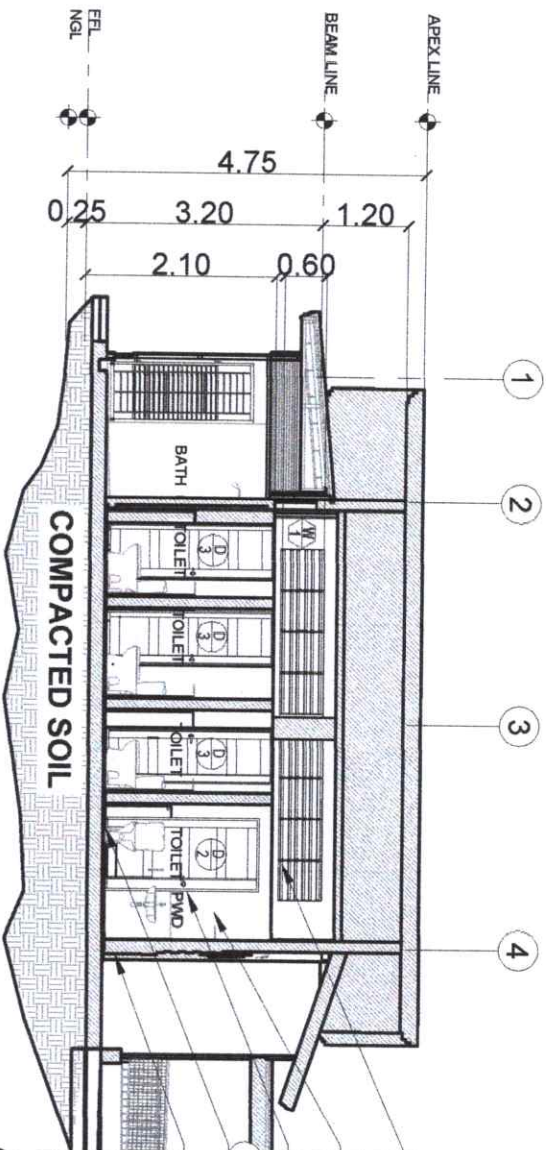

- EXISTING JALOUSIE WINDOW
- WALL TILES 16" X 16" (SEE MATERIALS SPEC.)
- EXISTING PANEL DOOR
- FLOOR TILES 24" X 24" (SEE MATERIALS SPEC.)
- BIDET (SEE MATERIAL SPEC.)

**SECTION THRU "A"**  
1:100 MTS

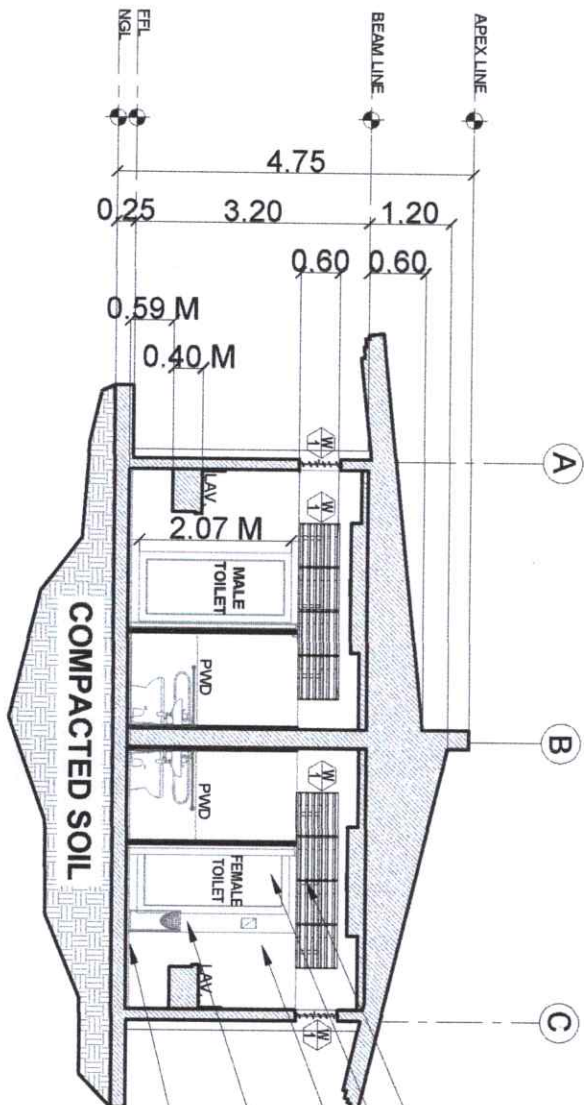


- EXISTING JALOUSIE WINDOW
- MIRROR 1.88 M. X 0.75 M.
- WALL FINE FINISH PAINTED (CRISP ECRU) (SEE MATERIALS SPEC.)
- WALL TILES 16" X 16" (POLISHED BLACK SLATE) (SEE MATERIALS SPEC.)
- FLOOR TILES 24" X 24" (CREAM WHITE) (SEE MATERIALS SPEC.)

**SECTION THRU "B"**  
1:100 MTS




Republic of the Philippines  
**CARLOS HILADO MEMORIAL  
STATE UNIVERSITY**  
Negros Occidental

<b>PROJECT TITLE:</b>	<b>REPAIR AND CONVERSION OF MALE AND FEMALE TOILETS TO ALL - GENDER COMFORT ROOMS</b>			
<b>ENDORSED BY:</b>	<b>ENDORSED BY:</b>	<b>CHECKED BY:</b>	<b>RECOMMENDING APPROVAL:</b>	
<i>[Signature]</i> DR. EDWIN H. BONGA CAMPUS DIRECTOR	<i>[Signature]</i> DR. ELVIE SAMSON GAD DIRECTOR	<i>[Signature]</i> ENGR. JUN-JUN MARQUEZ DIRECTOR PPDM	<i>[Signature]</i> MRS. ROSALINDA, TUVILA, J.D. VICE PRESIDENT FOR ADMINISTRATION	<i>[Signature]</i> FEDERICO V. DENISA JR., Ph.D. CAMPUS PHYSICAL PLANT AND FACILITIES MANAGING & DESIGN ENGINEER & ARCHITECT CAMPUS OUTDRAFTSMAN
<b>PROJECT LOCATION: ALIIS CAMPUS, BACOLOD CITY</b>		<b>SHEET NO. 4</b>		

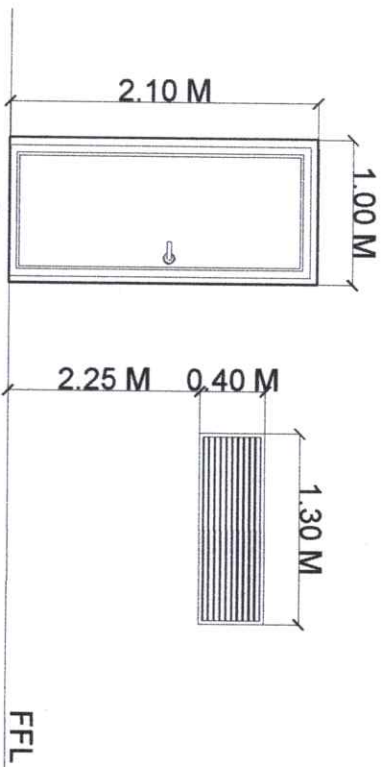

SCHEDULE OF DOORS AND WINDOW		
SCHEDULE	SIZE	LOCATION
1	1.30 M x 0.40 M	MAIN ENTRANCE
		SPECIFICATION
		STEEL DOOR

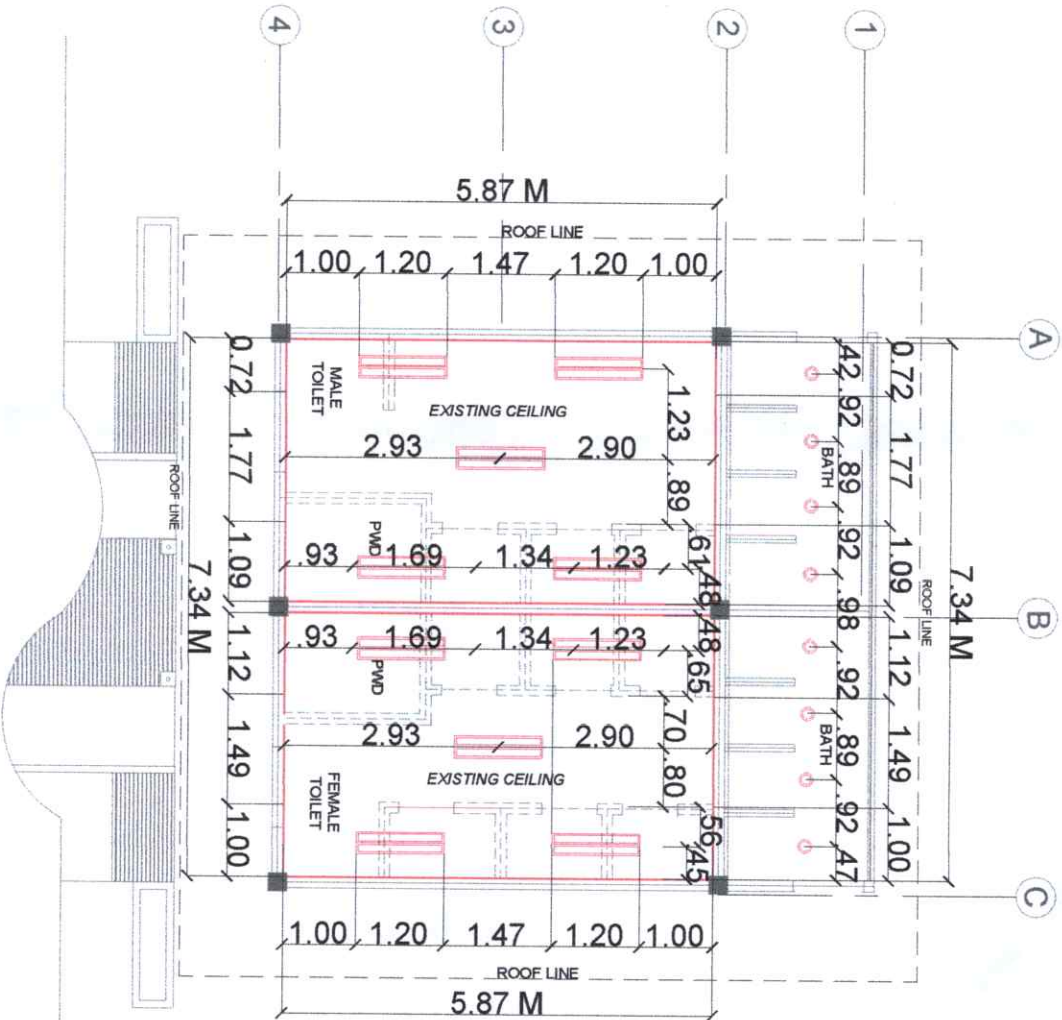

# 1 SCHEDULE OF DOOR AND WINDOWS

1:100 MTS

# 2 REFLECTED CEILING PLAN

1:100 MTS

	Republic of the Philippines CARLOS HILADO MEMORIAL STATE UNIVERSITY Negros Occidental	PROJECT TITLE: REPAIR AND CONVERSION OF MALE AND FEMALE TOILETS TO ALL - GENDER COMFORT ROOMS	ENDORSED BY: 	ENDORSED BY: 	CHECKED BY: 	RECOMMENDING APPROVAL: 	APPROVED: 	PREPARED / CHECKED BY: FEDERICO J. DENISA JR., P.A.D. CARLOS HILADO MEMORIAL STATE UNIVERSITY Negros Occidental	SHEET NO. A 5	PAGE NO. 5
	CAMPUS DIRECTOR	CAMPUS DIRECTOR	DIRECTOR PDM	VICE PRESIDENT FOR ADMINISTRATION	SIC PRESIDENT III					









Republic of the Philippines  
CARLOS HILADO MEMORIAL  
STATE UNIVERSITY  
Negros Occidental

PROJECT TITLE:	REPAIR AND CONVERSION OF MALE AND FEMALE TOILETS TO ALL-GENDER COMFORT ROOMS	ENDORSED BY:	DR. EDWIN H. BIGNA CAMPUS DIRECTOR	ENDORSED BY:	DR. ELVIE SAMSON GAD DIRECTOR	CHECKED BY:	ENGR. JUN-JUN MARQUEZ DIRECTOR PPOM	RECOMMENDING APPROVAL:	Mrs. ROSALINDA V. TUVILA, J.D. VICE PRESIDENT FOR ADMINISTRATION	SUC PRESIDENT III	PREPARED / CHECKED BY:	FEDERICO VIDENISA JR., P.H.D. CAMPUS PHYSICAL PLANT AND FACILITIES MANAGEMENT OFFICER CAMPUS OUTREACHS	SHEET NO.	PAGE NO.
													A 6	

# 1 URINAL PARTITION DETAILS

A/6 SCALE


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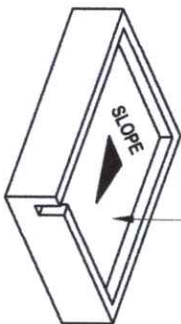
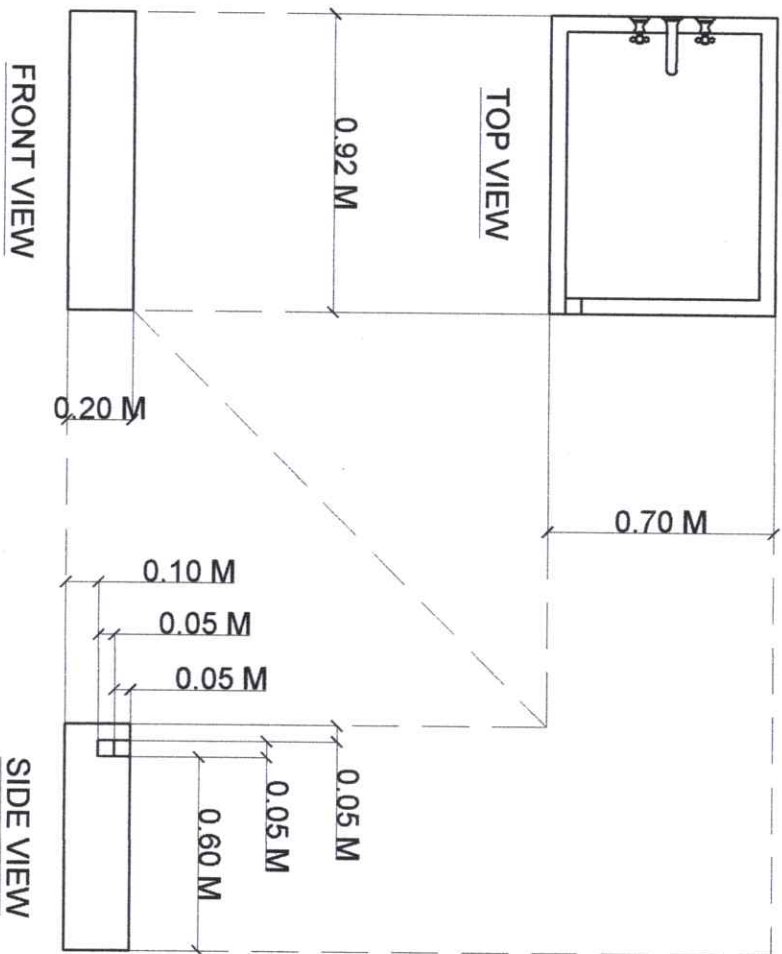
# 2 MESH WIRE COVER DETAILS

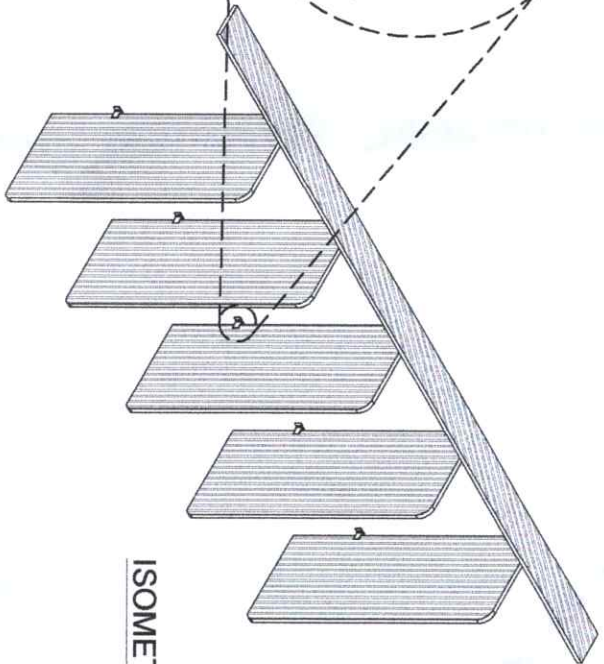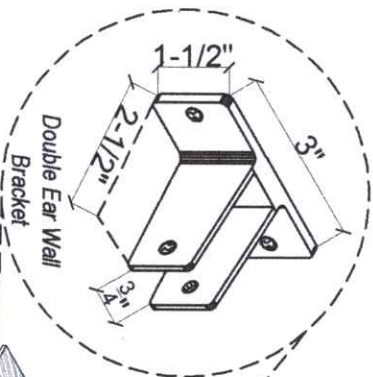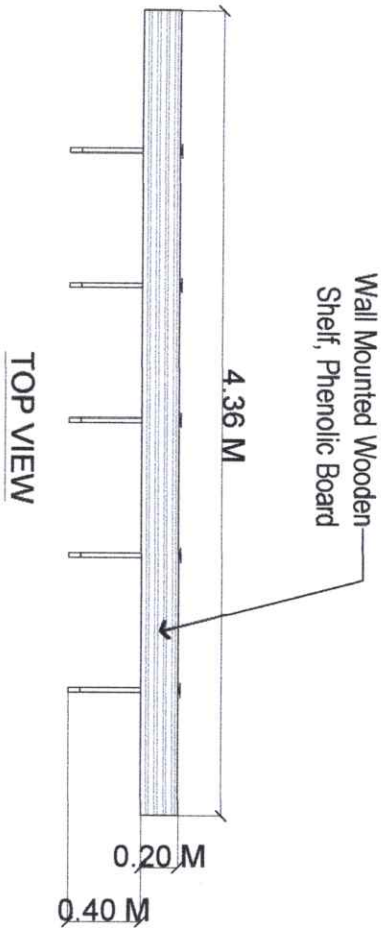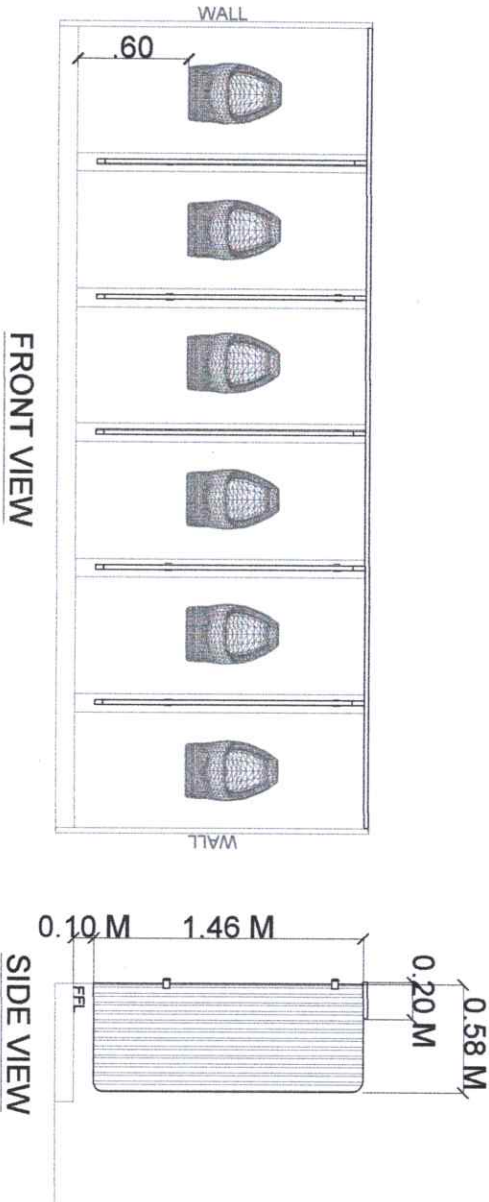A/6 SCALE


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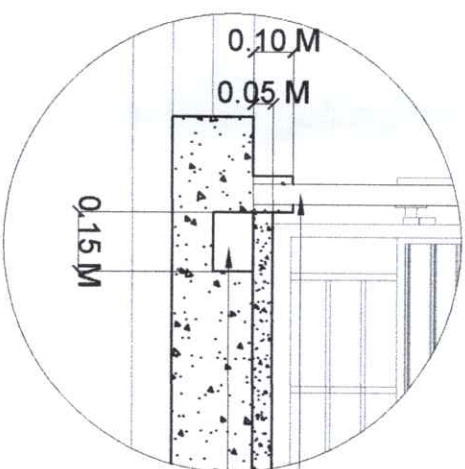
ANGLE BAR -  
(1" x 1" x 1/8")  
MESH WIRE 2"  
(4' x 8' x 2.6mm)



ISOMETRIC VIEW

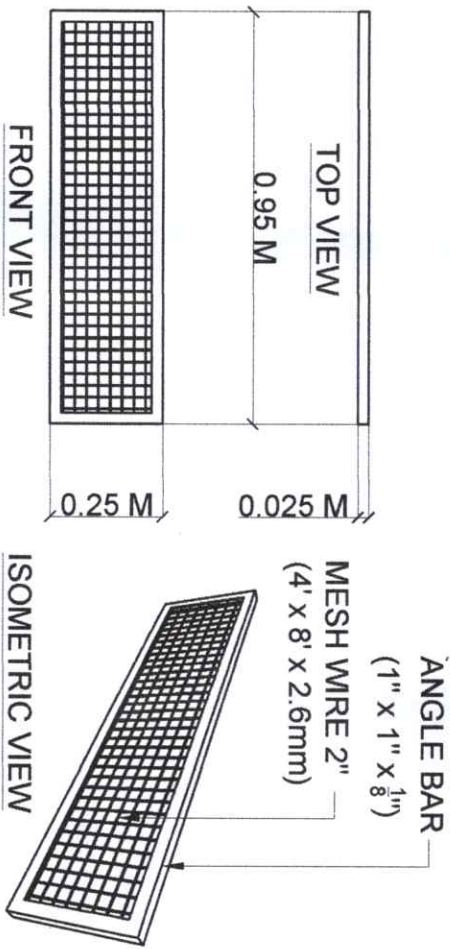


TUBULAR STEEL  
CANAL

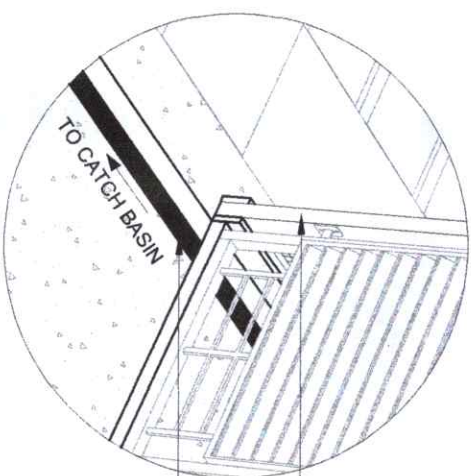


TUBULAR STEEL  
CANAL

# 1 SCALE FOOT WASH DETAIL NDTS

## 2 SCALE CANAL DETAIL NDTS

 <p>Republic of the Philippines CARLOS HILADO MEMORIAL STATE UNIVERSITY Negros Occidental</p>	<p>PROJECT TITLE: REPAIR AND CONVERSION OF MALE AND FEMALE TOILETS TO ALL-GENDER COMFORT ROOMS</p>	<p>ENDORSED BY: <i>[Signature]</i> DR. EDWIN H. BONGA CAMPUS DIRECTOR</p>	<p>ENDORSED BY: <i>[Signature]</i> DR. ELVIE SAMSON GAD DIRECTOR</p>	<p>CHECKED BY: <i>[Signature]</i> ENGR. GEM-JUN MARQUEZ DIRECTOR PDM</p>	<p>RECOMMENDING APPROVAL: <i>[Signature]</i> MRS. ROSALINDA V. TUYA, L.A., J.D. VICE PRESIDENT FOR ADMINISTRATION</p>	<p>APPROVED: <i>[Signature]</i> NORBERTO MANGULABNAN, Ph.D. SIC PRESIDENT III</p>	<p>PREPARED / CHECKED BY: <i>[Signature]</i> FEDERICO J. DENISA JR., P.H.D. CAMPUS PHYSICAL PLANT AND FACILITIES MANAGEMENT OFFICER CAMPUS OUTDRILL TRAINING</p>	<p>SHEET NO. PAGE NO. S 1</p>
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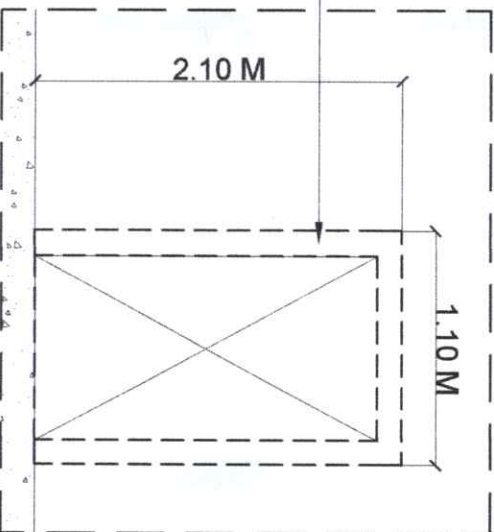


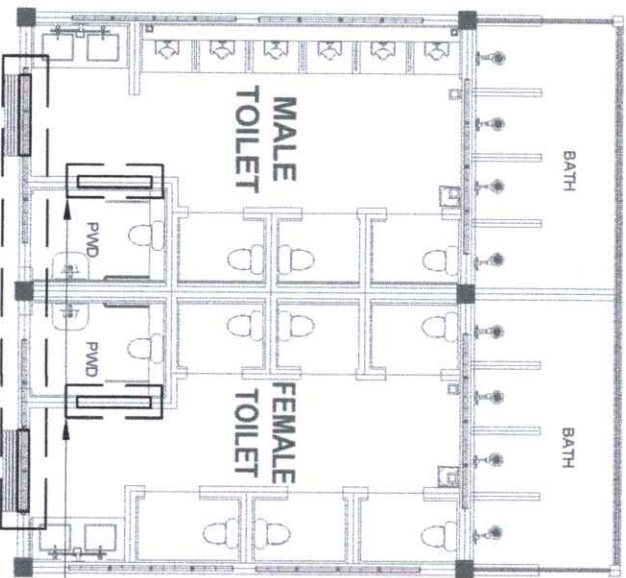

CONCRETE DOOR JAMB (SEE DETAIL)

SPOT DETAIL 1




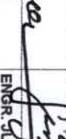



SPOT DETAIL 1




# CONCRETE WALL AND DOOR JAMB LOCATION PLAN

1  
SCALE

NDTS

	Republic of the Philippines <b>CARLOS HILADO MEMORIAL STATE UNIVERSITY</b> Negros Occidental	<b>PROJECT TITLE:</b> REPAIR AND CONVERSION OF MALE AND FEMALE TOILETS TO ALL - GENDER COMFORT ROOMS	<b>ENDORSED BY:</b>  DR. EDWIN H. BAGONA CAMPUS DIRECTOR	<b>ENDORSED BY:</b>  DR. ELVIE SAMSON GAD DIRECTOR	<b>CHECKED BY:</b>  ENGR. JUN-JUN MARQUEZ DIRECTOR PDM	<b>RECOMMENDING APPROVAL:</b>  MRS. ROSALINDA V. TUVILLA, J.D. VICE PRESIDENT FOR ADMINISTRATION	<b>APPROVED:</b>  NORBERTO P. MANGUALABAN, PH.D. SUC PRESIDENT II	<b>PREPARED / CHECKED BY:</b>  FEDERICO V. DENISA, JR., PH.D. CAMPUS PHYSICAL PLANT AND FACILITIES ENGINEER IN CHARGE	<b>SHEET NO.</b> S 2	<b>PAGE NO.</b> 2
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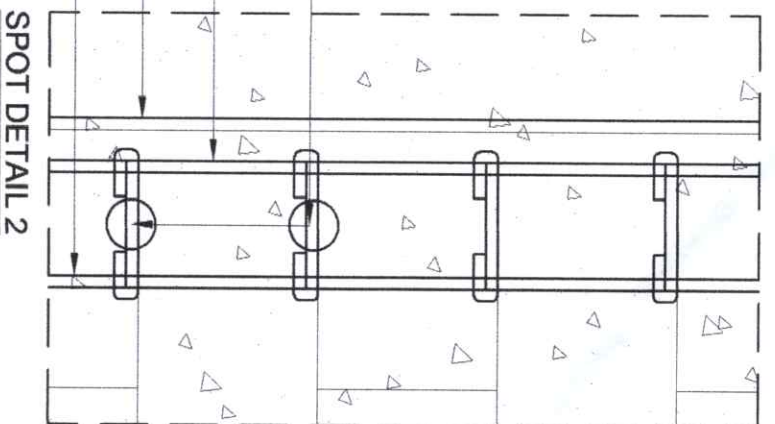
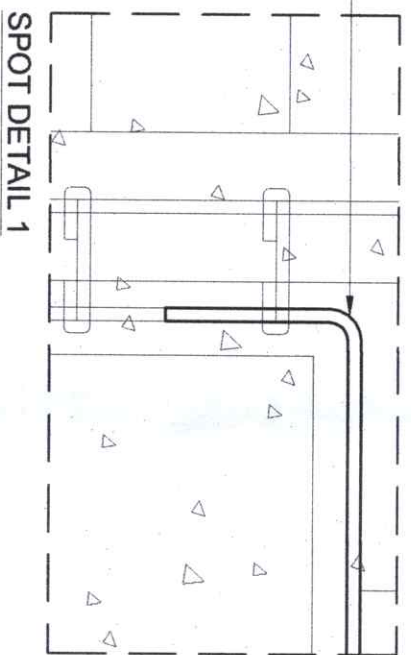
10MM Ø REBARS (BENDED)

8MM Ø REBARS AS DOWEL ANCHORED TO WALL REBARS SPACE @ .20M

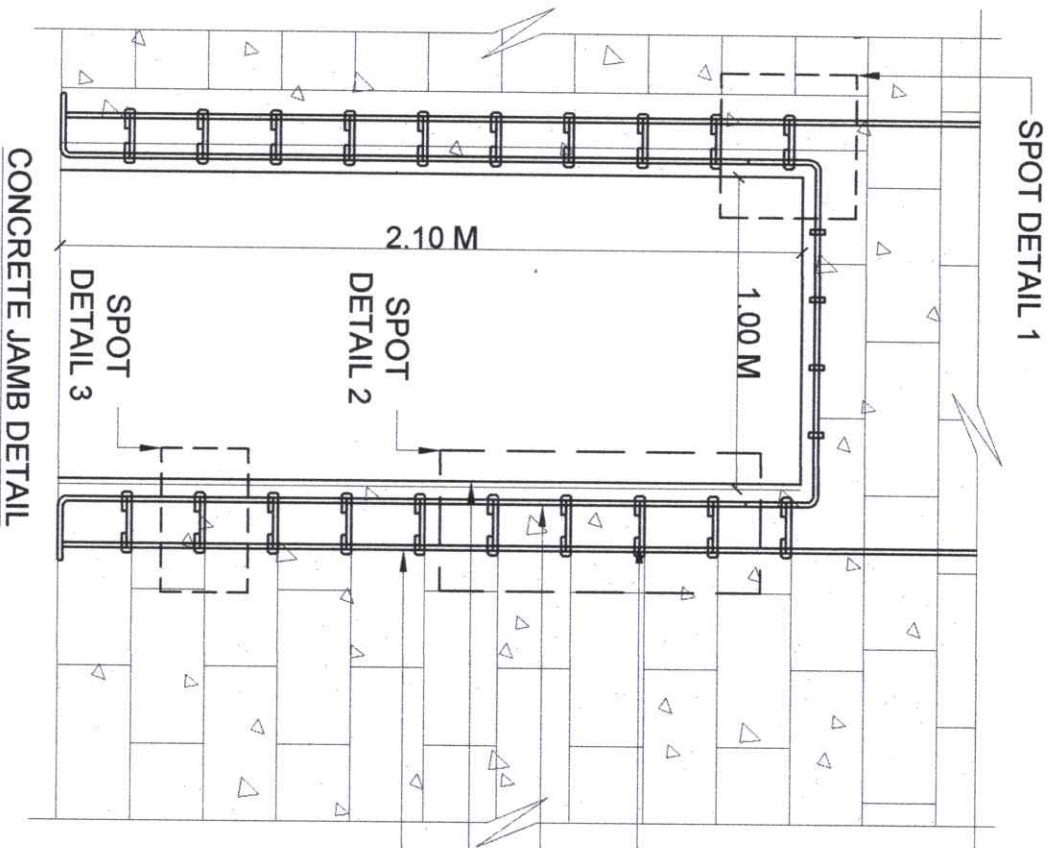
10MM Ø CONCRETE DOOR JAMB VERTICAL BARS




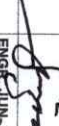



DOOR JAMB FINISH


WALL REBARS

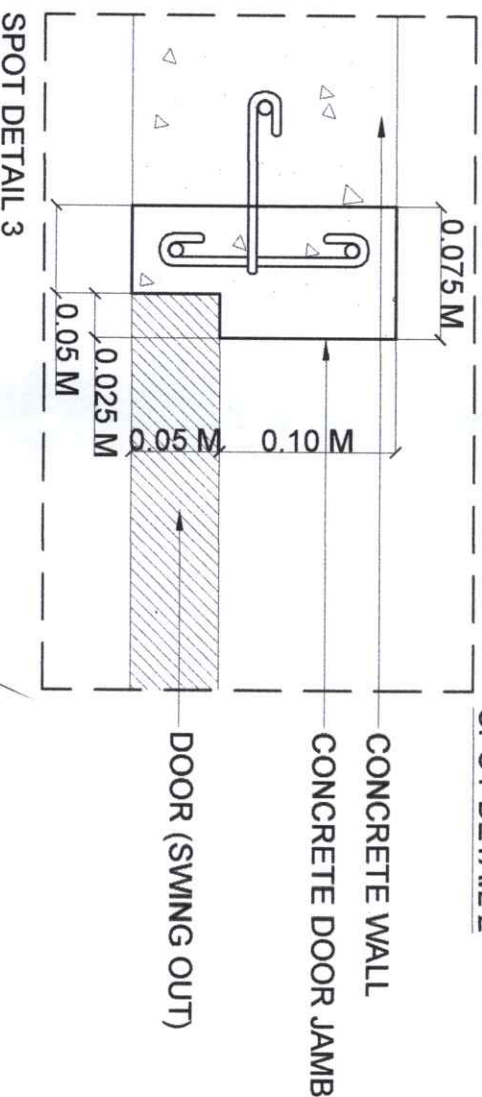


1 CONCRETE DOOR JAMB DETAIL (1) SCALE



 <p>Republic of the Philippines CARLOS HILADO MEMORIAL STATE UNIVERSITY Negros Occidental</p>	<p>PROJECT TITLE: REPAIR AND CONVERSION OF MALE AND FEMALE TOILETS TO ALL-GENDER COMFORT ROOMS</p>	<p>ENDORSED BY:  DR. EDWIN H. BUENA CAMPUS DIRECTOR</p>	<p>ENDORSED BY:  DR. ELVIE SAMSON GAD DIRECTOR</p>	<p>CHECKED BY:  ENGR. JUN-JUN MARQUEZ DIRECTOR PDM</p>	<p>RECOMMENDING APPROVAL:  MS. ROSALINDA V. TUVILLA, J.D. VICE PRESIDENT FOR ADMINISTRATION</p>	<p>APPROVED:  NORBERTO P. MANGULAAN, Ph.D. SUC PRESIDENT III</p>	<p>PREPARED BY:  FEDERICO V. DENISA JR. Ph.D. CAMPUS PHYSICAL PLANT AND FACILITIES MANAGEMENT DIVISION CAMPUS OUT DRAFTSMAN</p>	<p>SHEET NO. 3</p>
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ISOMETRIC DETAIL

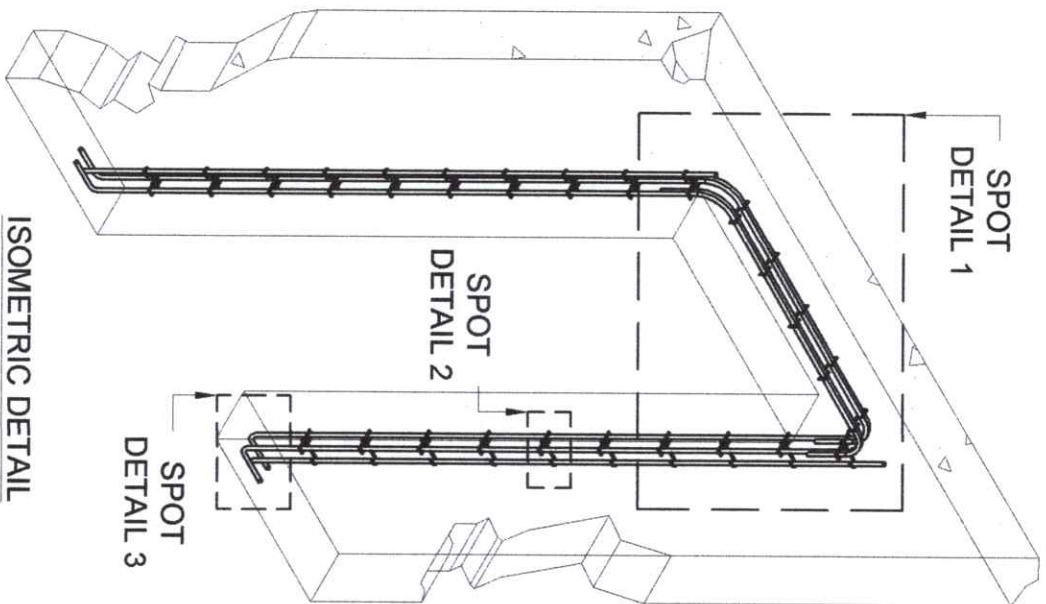

SPOT DETAIL 1 END BAR BENDED

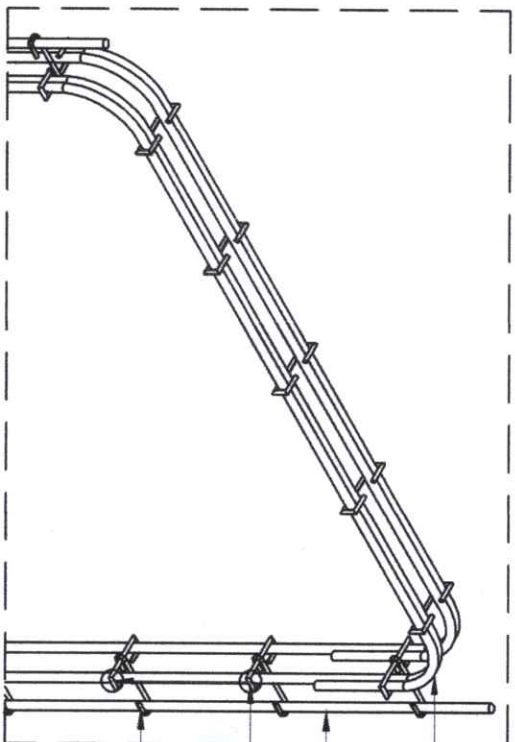10MM Ø VERTICAL BARS BENDED AT  
OPPOSITE END ANGLE  
WALL REBARS  
8MM Ø REBARS LATERAL TIES SPACED  
@ .20 M  
8MM Ø REBARS DOWEL ANCHORED TO  
WALL REBARS SPACE @ .20M

8MM Ø REBARS LATERAL TIES SPACE @ .20M


8MM Ø REBARS (DOWEL) SPACE @ .20M

10MM Ø REBARS VERTICAL BARS


WALL REBARS

WALL REBARS

10MM Ø VERTICAL BARS (BENDED BELOW)

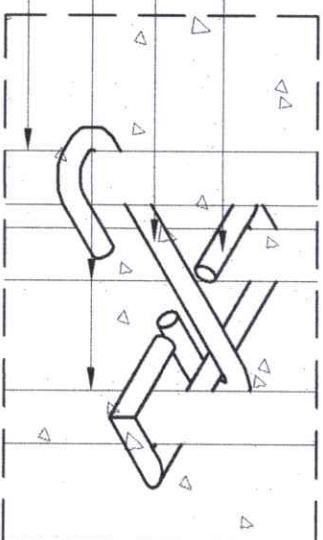

SPOT DETAIL 2 DOWEL / LATERAL TIES

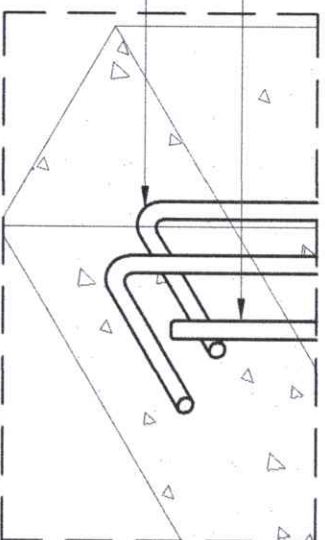

SPOT DETAIL 3 END BAR BENDED

**1** **CONCRETE DOOR JAMB DETAIL (2)**  
**S4** SCALE NDTs




Republic of the Philippines  
CARLOS HILADO MEMORIAL  
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Negros Occidental

PROJECT TITLE:	REPAIR AND CONVERSION OF MALE AND FEMALE TOILETS TO ALL - GENDER COMFORT ROOMS	ENDORSED BY:	ENDORSED BY:	CHECKED BY:	RECOMMENDING APPROVAL:	APPROVED:	PREPARED / CHECKED BY:	SHEET NO.	PAGE NO.
PROJECT LOCATION: ALIJS CAMPUS, BACOLOLO CITY		DR. EDWIN H. BONGMA CAMPUS DIRECTOR	DR. ELVIE SAMSON GAD DIRECTOR	ENGR. JUN-JUN MARQUEZ DIRECTOR PPDM	MRS. ROSALINDO V. TUVILLA, J.D. VICE PRESIDENT FOR ADMINISTRATION	NORBERTO P. MANGULABNAN, Ph.D. SUC PRESIDENT	FEDERICO DENISA, JR., Ph.D. CARLOS HILADO MEMORIAL STATE UNIVERSITY CAMPUS OUTREACH TRAINING	S4	4





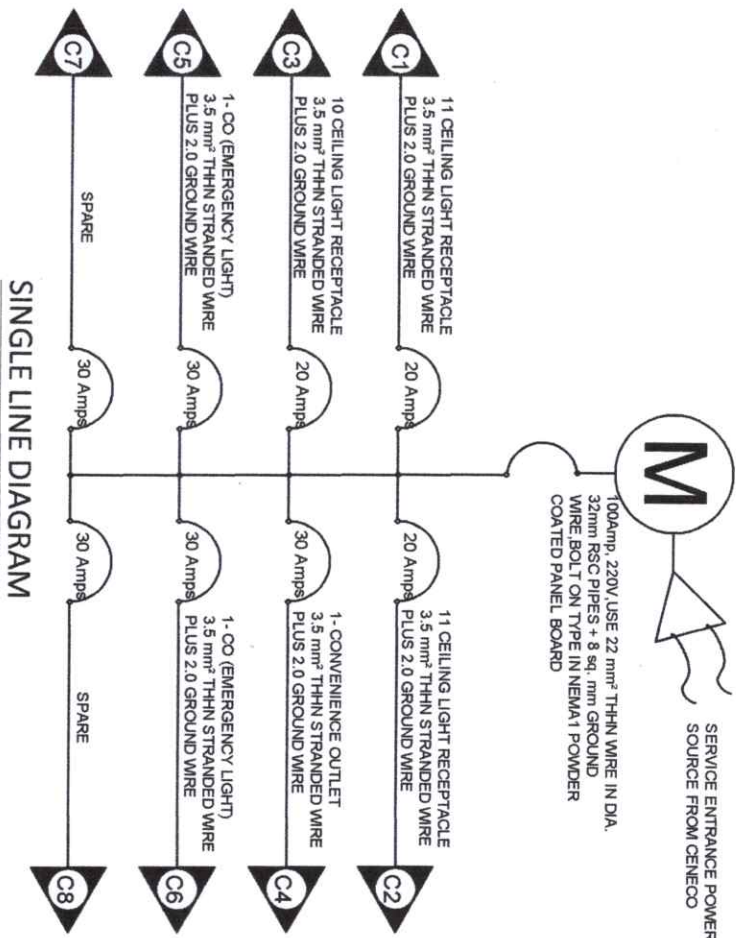

## ELECTRICAL SPECIFICATIONS

1. ALL ELECTRICAL WORKS AND INSTALLATION SHALL COMPLY WITH THE PROVISIONS OF THE LATEST EDITION OF THE PHILIPPINE ELECTRICAL CODE, REPUBLIC ACT NO. 7920, RULES AND REGULATIONS OF THE NATIONAL AND LOCAL CIVIL AUTHORITIES AND IN CONSONANT WITH THE UTILITY COMPANY.
2. THE ELECTRICAL INSTALLATION SHALL BE UNDER THE DIRECT SUPERVISION OF THE DULY LICENSED ELECTRICAL ENGINEER AS PROVIDED IN THE RA NO. 7920.
3. THE MAIN SERVICE ENTRANCE CONDUCTOR SHALL BE 22 mm<sup>2</sup> THHN COPPER WIRE IN PLUS 8.00 mm<sup>2</sup> THHN GROUND WIRE 1 1/2 DIA. CONDUIT.
4. THE MAIN CIRCUIT BREAKER SHALL BE 40 AMPERES, MOLDED CASE CIRCUIT BREAKER, 220 VOLTS, SINGLE POLES AS INDICATED IN THE SCHEDULE OF LOADS AND SINGLE LINE DIAGRAM. EACH CIRCUIT PROTECTION SHALL HAVE A CIRCUIT BREAKER WITH 25 KAIC. THE AMPACITY RATING IS INDICATED IN THE SCHEDULE OF LOADS.
5. THE SIZES OF THE BRANCHES CONDUCTORS SHALL BE IN ACCORDANCE WITH THE TABULATED SCHEDULE OF LOADS AND PLACED INSIDE A RIGID STEEL CONDUIT. ALL WIRES SHALL BE THW OR THHN.
6. REVISIONS, ALTERATION IN THE DESIGN SHALL BE DONE WITH THE PRIOR APPROVAL OF THE DESIGNING ELECTRICAL ENGINEER AND THE OWNER. ANY LOAD NOT FOUND IN HE ELECTRICAL PLAN HAS NOT BEEN CONSIDERED IN THE DESIGN.
7. ALL MATERIALS SHALL BE BRAND NEW AND UL LISTED.

## SCHEDULE OF LOADS

CKT NO.	LOAD DESCRIPTION	VOLTS	WATTS	AMPS.	CIRCUIT PROTECTION	WIRE	CONDUIT
C1	CEILING LIGHTING OUTLET	220	1100	5	20A	3.5 mm <sup>2</sup> THW wire	20 mmØ PVC
C2	CEILING LIGHTING OUTLET	220	1100	5	20A	3.5 mm <sup>2</sup> THW wire	20 mmØ PVC
C3	CEILING LIGHTING OUTLET	220	1000	4.54	20A	3.5 mm <sup>2</sup> THW wire	20 mmØ PVC
C4	CONVENIENCE OUTLET	220	360	1.63	30A	3.5 mm <sup>2</sup> THW wire	20 mmØ PVC
C5	CONVENIENCE OUTLET	220	360	1.63	30A	3.5 mm <sup>2</sup> THW wire	20 mmØ PVC
C6	CONVENIENCE OUTLET	220	360	1.63	30A	3.5 mm <sup>2</sup> THW wire	20 mmØ PVC
C7	SPARE	220	1500	6.81	30A	3.5 mm <sup>2</sup> THW wire	20 mmØ PVC
C8	SPARE	220	1500	6.81	30A	3.5 mm <sup>2</sup> THW wire	20 mmØ PVC
				33.05			

Wire size and Cir. Breaker









ITOTAL = 33.05 x 1.25 = 41.31

ITOTAL = 41.31



Wire Size= use 22 mm<sup>2</sup> THHN Wire in Dia.

32 mm RSC pipes + 8 sq. mm ground wire

Cir. Breaker= Use 100 amp. 2 poles

	Republic of the Philippines <b>CARLOS HILADO MEMORIAL STATE UNIVERSITY</b> Negros Occidental	PROJECT TITLE: <b>REPAIR AND CONVERSION OF MALE AND FEMALE TOILETS TO ALL-GENDER COMFORT ROOMS</b>	ENDORSED BY:  DR. EDWIN H. BORNA CAMPUS DIRECTOR	ENDORSED BY:  DR. ELVIE SAMSON GAD DIRECTOR	CHECKED BY:  ENGR. SON-JUN MARQUEZ DIRECTOR PDM	RECOMMENDING APPROVAL:  Mrs. ROSALINDA V. TUVILLA, J.D. VICE PRESIDENT FOR ADMINISTRATION	APPROVED:  NORBERTO P. MANGULABNAN, Ph.D. SUC PRESIDENT	PREPARED BY:  FEDERICO V. DENISA, JR., P.E. CAMPUS PHYSICAL PLANT AND FACILITIES ENGINEER & ASST. CAMPUS S. GERONIA	CHECKED BY:  FEDERICO V. DENISA, JR., P.E. CAMPUS PHYSICAL PLANT AND FACILITIES ENGINEER & ASST. CAMPUS S. GERONIA	SHEET NO. <b>E 2</b>	PAGE NO.
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LEGEND	
	WASTE PIPE
	SOIL PIPE
	WATER PIPE
	CLEAN OUT
	FLOOR DRAIN
	SHOWER
	WATER FAUCET
	SEPTIC VAULT
	CATCH BASIN
	GATE VALVE
	GATE VALVE
	WATER METER


1 PLUMBING LAYOUT PLAN  
SCALE  
1:100 MTS

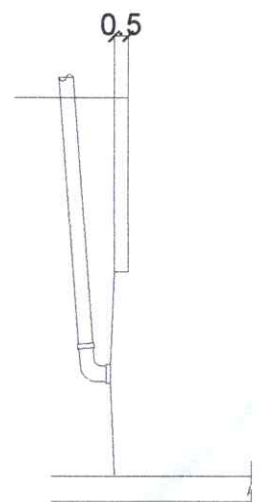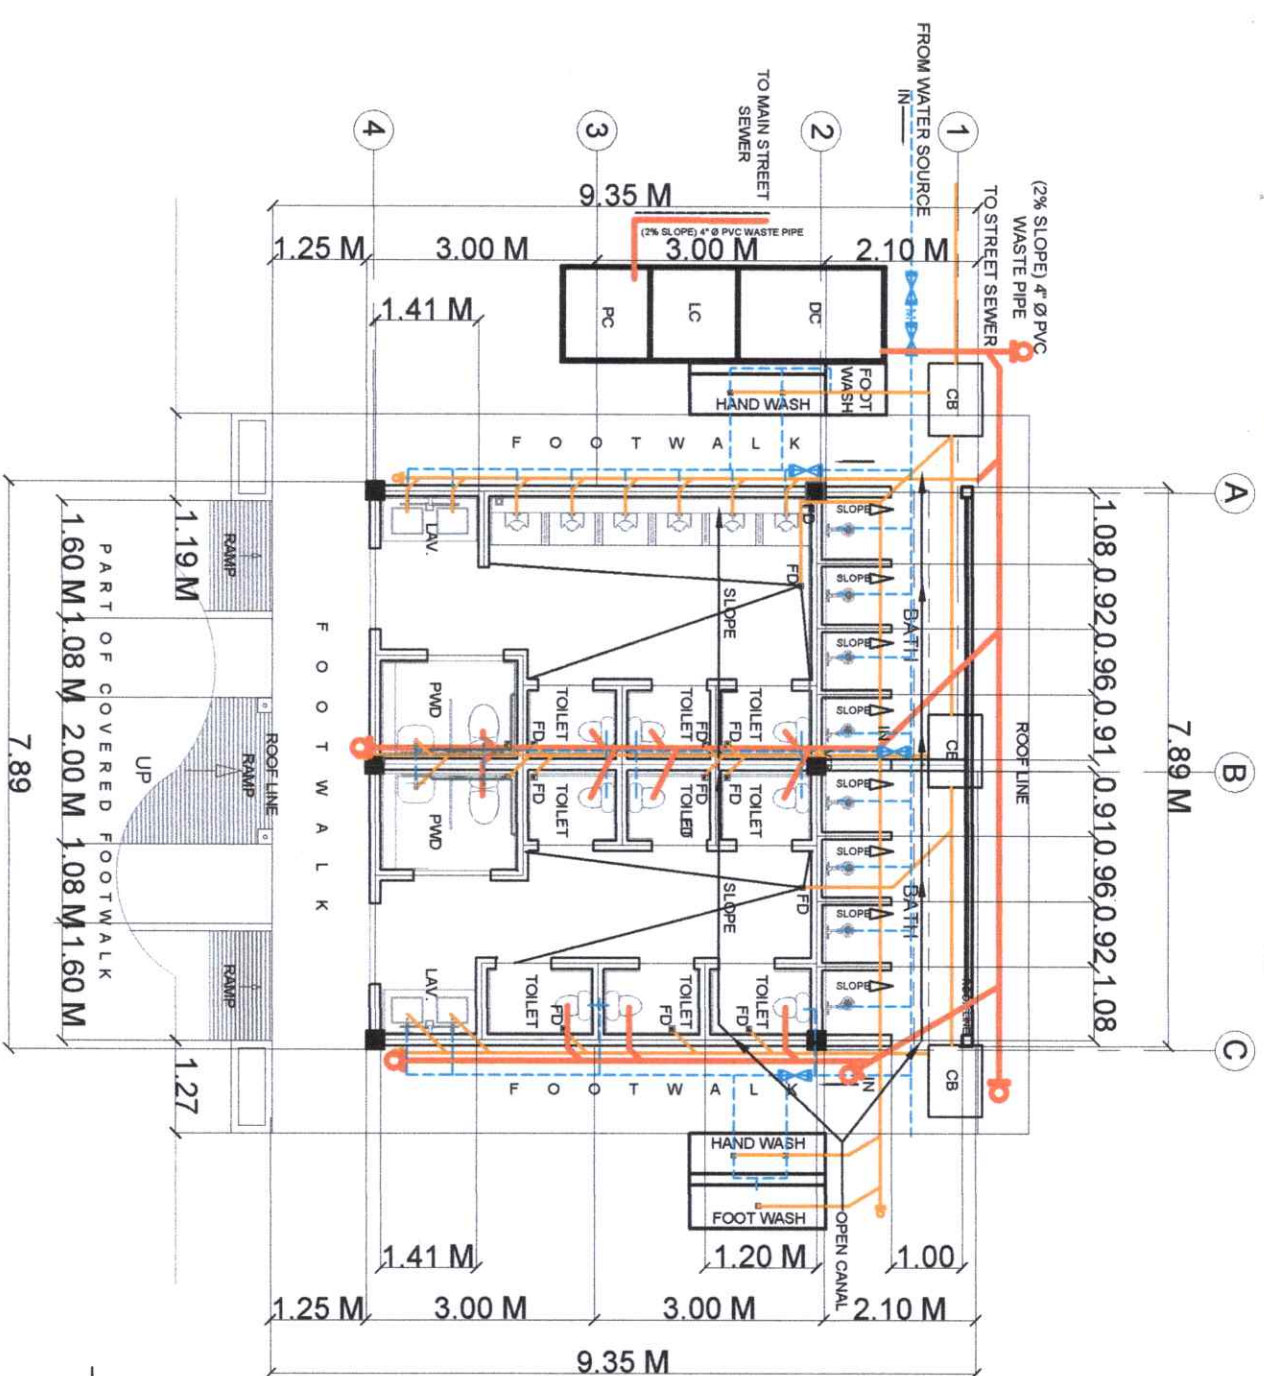	Republic of the Philippines CARLOS HILADO MEMORIAL STATE UNIVERSITY Negros Occidental	PROJECT TITLE: REPAIR AND CONVERSION OF MALE AND FEMALE TOILETS TO ALL-GENDER COMFORT ROOMS	ENDORSED BY: 	ENDORSED BY: 	CHECKED BY: 	RECOMMENDING APPROVAL: 	APPROVED: 	PREPARED / CHECKED BY: FEDERICO V. DENISA JR., P.A.D. CAMPUS PHYSICAL PLANNING AND FACILITIES MANAGEMENT DIVISION CAMPUS PLANNING & DESIGN	SHEET NO. P 1	PAGE NO. 1	
PROJECT LOCATION: ALJOS CAMPUS, BACOLOLO CITY		CAMPUS DIRECTOR		GAD DIRECTOR		VICE PRESIDENT FOR ADMINISTRATION		SUC PRESIDENT III			






**1 PERSPECTIVE**  
CS SCALE NDTs

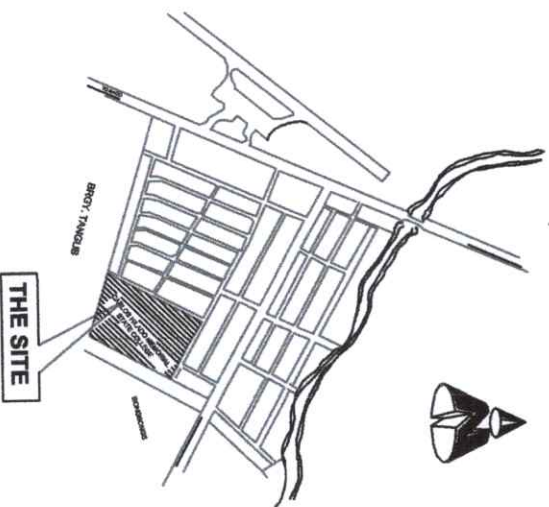

**2 VICINITY MAP**  
CS SCALE NDTs

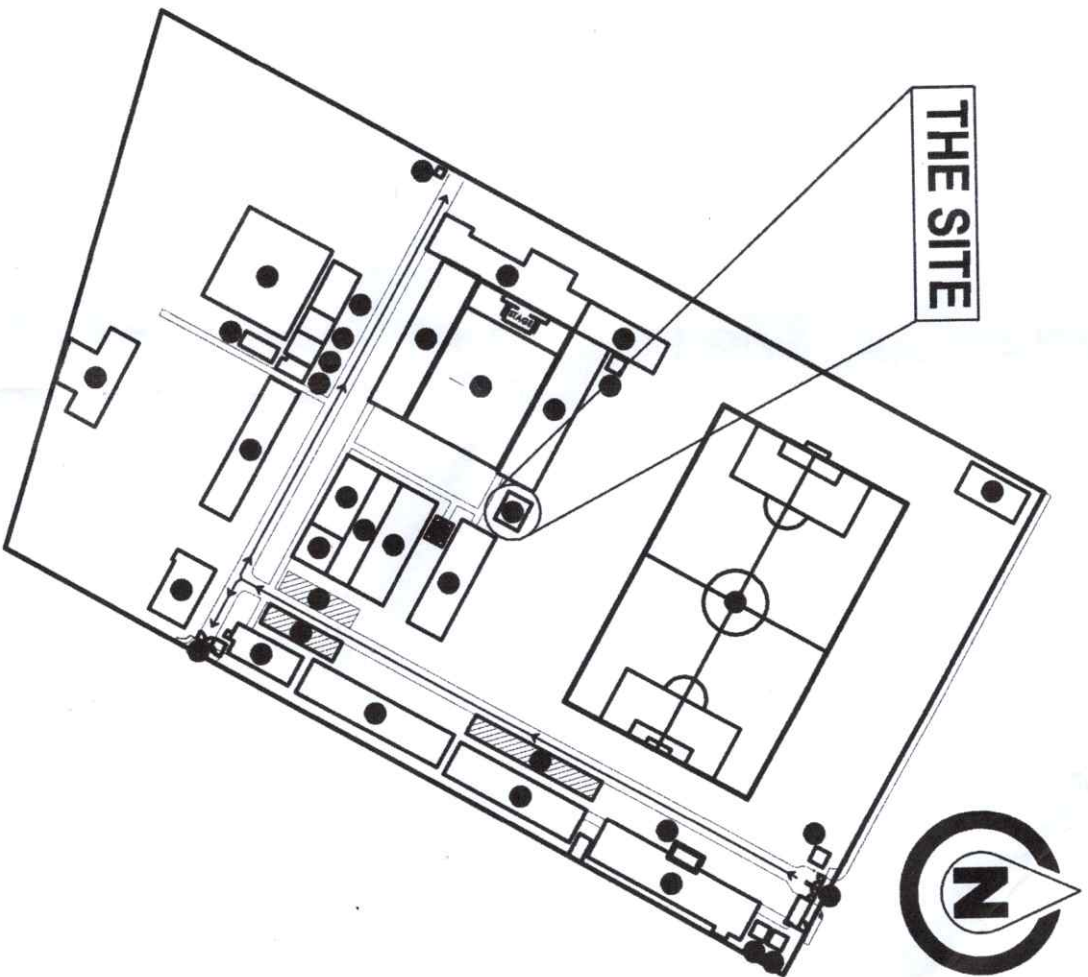

**3 SITE DEVELOPMENT PLAN**  
CS SCALE NDTs



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Negros Occidental

<b>PROJECT TITLE:</b>		<b>ENDORSED BY:</b>	<b>ENDORSED BY:</b>	<b>CHECKED BY:</b>	<b>RECOMMENDING APPROVAL:</b>	<b>APPROVED:</b>	<b>PREPARED CHECKED BY:</b>	<b>SHEET NO.</b>	<b>PAGE NO.</b>
REPAIR AND CONVERSION OF MALE AND FEMALE TOILETS TO ALL-GENDER COMFORT ROOMS		<i>[Signature]</i>	<i>[Signature]</i>	<i>[Signature]</i>	<i>[Signature]</i>	<i>[Signature]</i>	<i>[Signature]</i>	<b>C</b>	<b>S</b>
PROJECT LOCATION: ALJIS CAMPUS, BACOLOD CITY		DR. EDWIN H. BUGNA CAMPUS DIRECTOR	DR. ELVIE SAMSON GAD DIRECTOR	DR. JIM-JUN MARQUEZ DIRECTOR PPDM	MS. ROSALINDA V. TUVILLA, J.D. VICE PRESIDENT FOR ADMINISTRATION	NORBERTO P. MANGULABNAN, Ph.D. SUC PRESIDENT III	FEDERICO V. DENISA JR., Ph.D. CARLOS PHYSICAL PLANT AND FACILITIES MANAGING ENGINEER & REGISTRAR CAMPUS COT DRAFTSMAN		